## GENERAL NOTES:

- 1. GENERAL NOTES APPLY TO ALL TRADES WORKING ON THE PROJECT.

LOCKER ROOM

(114)

CORR. (120)

 $\square$ 

STORAGE (115)

WAITING ROOM

EVIDENCE (113)

OFFICE (112)

PHASE 1a

REFER TO SHEET A-10 FOR EXTENT OF WORK

EVIDENCE

FILES (109)

JAN. (136)

INVESTIGATORS

COUNCIL CHAMBERS

CONFERENCE ROOM

PHASE 4

NETWORK (133)

MECH'L (131)

REFER TO SHEET A-4 FOR EXTENT OF JWORK

OFFICE (158)

BUILDING DEPT. (156)

REFER TO SHEET A-3 FOR EXTENT OF WORK (154)

PHASE 3

PHASE 2/ REFER TO SHEET AFFE

COPY/MAIL (148)

CORR. / STORAGE (149) INSPECTION (157)

WAITING AREA

CORR. (145)

-3 1

ASST. CITY MANAGER
(144)

VEŞT. (140)

LOBBY (141)

CORR. (142)

VESTIBULE (143)

EINANCE DIRECTOR (159)

CORRIDOR (155)

YAULI (160)

UTILITIES (153)

ACCOUNTING (152)

BREAK ROOM

- 3. VERIFY ALL DIMENSIONS AND REQUIRED CLEARANCES BETWEEN EXISTING CONDITIONS AND SHOP DRAWINGS PRIOR TO FABRICATION AND INSTALLATION.
- 4. CONDUCT OPERATIONS SO AS TO PERMIT PUBLIC ACCESS TO THE EXISTING BUILDINGS. WALKS DRIVEWAYS AND ENTRANCES TO BE USE BY THE PUBLIC SHALL BE MAINTAINED IN A SAFE CONDITION AND SHALL BE KEPT FREE AND CLEAR OF THE CONTRACTOR'S EQUIPMENT, MATERIALS AND DEBRIS.
- THE DRAWINGS SHOW EXISTING CONDITIONS AS ACCURATE AS POSSIBLE 5. BIASED ON AVAILABLE INFORMATION, CONTRACTOR(S) SHALL FIELD VERIFY ALL DIMENSIONS, LOCATIONS, UTILITIES, EQUIPMENT, ETC., PRIOR TO START OF NEW CONSTRUCTION. REPORT ANY DISCREPANCIES TO THE ARCHITECT BEFORE PROCECDING WITH THE WORK.
- CONTRACTOR(S) SHALL COOPERATE WITH THE OWNER IN THE SCHEDULING
  6. AND EXECUTION OF THE WORK AND USE OF THE SITE. CONTRACTOR'S
  SHALL NOTIFY THE OWNER/ARCHITECT A MINIMUM OF 48 HOURS BEFORE
  COMMENCEMENT OF ANY WORK OR OPERATION WHICH WOULD INTERFERE
  WITH THE USE OF THE EXISTING BUILDING.
- CONTRACTOR'S OPERATION AND STORAGE OF MATERIALS SHALL BE CONFIRMED THE THE MINIMUM AREA(S) OF THE SITE NECESSARY TO ACCOMPLISH THE WORK. THE LOCATION OF THE AREA(S) SHALL BE APPROVED BY THE OWNER.

- CONTRACTOR(S) SHALL EXERCISE ALL REASONABLE PRECAUTIONS FOR THE PROTECTION OF PERSONS AND PROPERTY ON THE SITE. SAFETY PROVISIONS OF APPLICABLE LAWS AND BUILDING AND CONSTRUCTION CODES SHALL BE OBSERVED.
- CONTRACTOR(S) SHALL PROTECT THEIR WORK, THE WORK OF OTHER AND EXISTING WORK SHOWN TO REMAIN DO NOT DAMAGE MATERIALS SHOWN TO REMAIN IN PLACE. ANY WORK DAMAGED BY CONTRACTOR(S) SHALL BE RETURNED TO THE CONDITION PRIOR TO DAMAGE AND EQUAL TO ADJACENT SUBJECTED.
- 10. EXISTING EMERGENCY EGRESS SHALL BE MAINTAINED IN ALL SITUATIONS
- SECURITY SHALL BE MAINTAINED IN ALL SITUATIONS. MAKE PROVISIONS SO THAT THE NORMAL FUNCTIONS OF THE BUILDING CAN BE MAINTAINED THROUGH THE DEMOLITION, REMODELING, AND NEW CONSTRUCTION PERIOD.
- CONTRACTOR SHALL PROVIDE TEMPORARY DUST PROOF ENCLOSURES, DUST BARRIERS, COVERED WALKWAYS AND/OR BARRICADES AS REQUIRED TO 2. PROTECT THE PUBLIC, COCUPANTS AND EXISTING FACILITIES DURING DEMOLITION AND NEW CONSTRUCTION OPERATIONS. CORRIDORS, PASSAGEWAYS AND EMERGENCY EXITS MUST BE KEPT OPEN AND FREE FOR USE AND ACCESS BY OWNER AND THE PUBLIC.
- CONTRACTOR SHALL SEAL ALL PENETRATIONS THROUGH FLOORS, CEILINGS, IRREPROOFING, PERMANENT PARTITIONS, FIRE WALLS AND OTHER FIRE RESISTIVE OR SMOKE CONTROL CONSTRUCTION. CONTRACTOR SHALL SEAL PENETRATIONS SMOKE TIGHT. METAL TRIM OR ESCUTCHEONS ALONE SHALL NOT BE ACCEPTABLE.



REVISIONS

# PLAN LEXINGTON MUNICIPAL BUILDING **NEBRASKA** FLOOR LEXINGTON, OVERALL

VERIFY SCALES


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IF NOT ONE INCH ON THIS SHEET, ADJUST SCALES ACCORDINGLY.

PROJECT NO. 127-G1-098 DATE:


OCTOBER 2008 FIELD BOOK M&A DWG NO N/A
DRAWN BY: APRVD BY: SHEET

A-0

CORRIDOR (117) SERGEANTS (117) MEN (137) PHASE 1b REFER TO SHEET A-1b FOR EXTENT OF WORK HOSE TOWER (103) CHIEF OF POLICE CORR. (120) INTERVIEW (129) EQUIPMENT (127) INTERVIEW (126) PASSAGE (128) пии 101LET (123) STORAGE (124) / YESI. (122) OVERALL FLOOR PLAN - PHASING PLAN
SCALE: 1/8" = 1'-0"

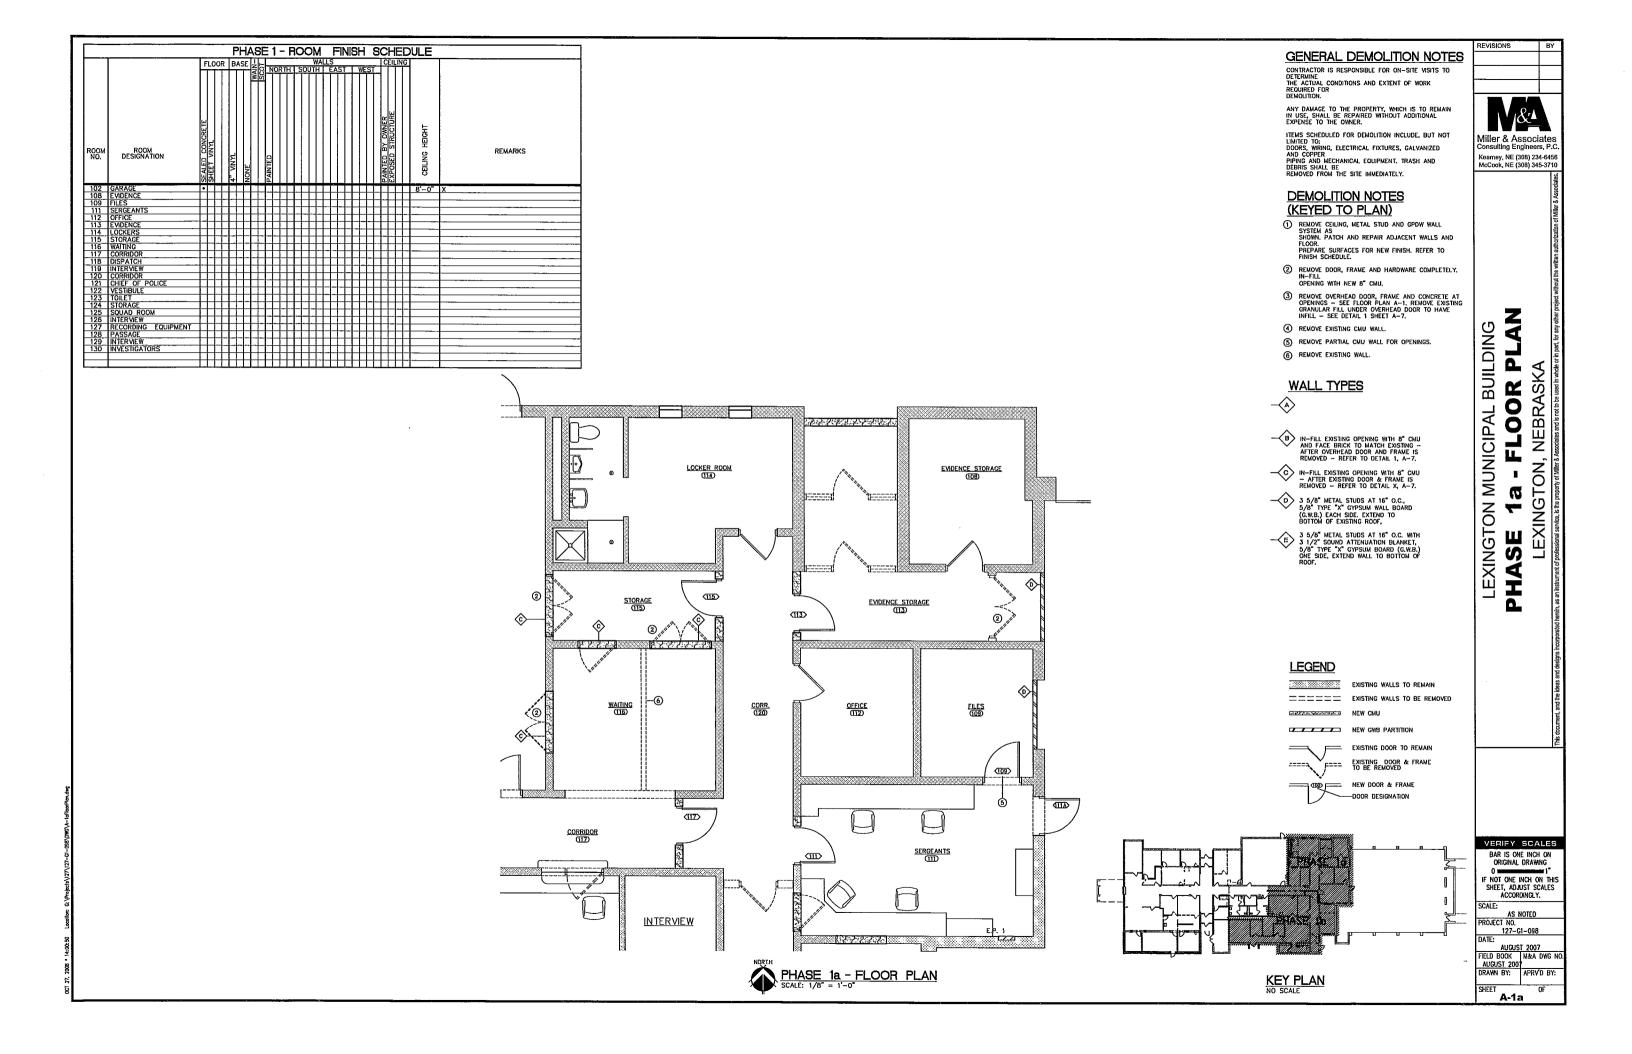

	PHASE 1 - DOOR SCHEDULE														
MARK	TYPE	WIDTH	HEIGHT	THICHN'S	FRAME	LABEL	HDWR.	REMARKS							
108	1	3'-0"	7'-0"	1 3/4"	AL #1		1	DETAIL 1, 2, 3							
109		3'-0"	7'-0"	1 3/4"											
111		3'-0"	7'-0"	1 3/4"											
111A		3'-0"	7'-0"	1 3/4"											
113		3'-0"	7'~0"	1 3/4"											
115		3'-0°	7'-0"	1 3/4"											
117		3'-0"	7'-0"	1 3/4"											
122	_	3'-0"	7'-0"	1 3/4"											
124		3'-0"	7'-0"	1 3/4"											
		i i													

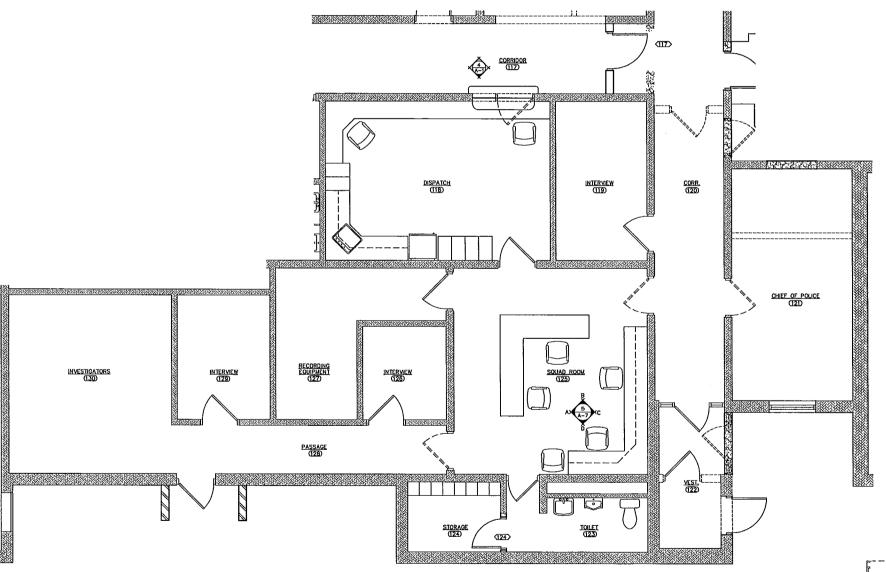

PHASE 1b - FLOOR PLAN
SCALE: 1/8" = 1'-0"

**GENERAL DEMOLITION NOTES** 

CONTRACTOR IS RESPONSIBLE FOR ON-SITE VISITS TO DETERMINE THE ACTUAL CONDITIONS AND EXTENT OF WORK REQUIRED. FOR

ANY DAMAGE TO THE PROPERTY, WHICH IS TO REMAIN IN USE, SHALL BE REPAIRED WITHOUT ADDITIONAL EXPENSE TO THE OWNER.

ITEMS SCHEDULED FOR DEMOLITION INCLUDE, BUT NOT LIMITED TO: DOORS, WIRING, ELECTRICAL FIXTURES, GALVANIZED AND COPPER PIPING AND MECHANICAL EQUIPMENT. TRASH AND DEBRIS SHALL BE REMOVED FROM THE SITE IMMEDIATELY.

## **DEMOLITION NOTES** (KEYED TO PLAN)

- TREMOVE CEILING, METAL STUD AND GPDW WALL SYSTEM AS SHOWN, PATCH AND REPAIR ADJACENT WALLS AND FLOOR. PREPAIR SUPFACES FOR NEW FINISH. REFER TO FINISH SCHEDULE.
- ② REMOVE DOOR, FRAME AND HARDWARE COMPLETELY.
  IN-FILL
  OPENING WITH NEW 8" CMU.
- (3) REMOVE OVERHEAD DOOR, FRAME AND CONCRETE AT OPENINGS SEE FLOOR PLAN A-1, REMOVE EXISTING GRANULAR FILL UNDER OVERHEAD DOOR TO HAVE INFILL SEE DETAIL 1 SHEET A-7.
- REMOVE EXISTING CMU WALL.
- (5) REMOVE PARTIAL CMU WALL FOR OPENINGS.
- 6 REMOVE EXISTING WALL.

## WALL TYPES

- A IN-FILL EXISTING OPENING WITH 8" CMU AND FACE BRICK TO MATCH EXISTING AFTER EXISTING WINDOW & FRAME IS REMOVED REFER TO DETAIL X, A-7.
- HE IN-FILL EXISTING OPENING WITH 8" CMU AND FACE BRICK TO MATCH EXISTING AFTER OVERHEAD DOOR AND FRAME IS REMOVED REFER TO DETAIL 1, A-7.
- C IN-FILL EXISTING OPENING WITH 8" CMU
   AFTER EXISTING DOOR & FRAME IS
  REMOVED REFER TO DETAIL X, A-7.
- 3 5/8" METAL STUDS AT 16" O.C.,
  5/8" TYPE "X" GYPSUM WALL BOARD
  (G.W.B.) EACH SIDE, EXTEND TO
  BOTTOM OF EXISTING ROOF,
- 3 5/8" METAL STUDS AT 16" O.C. WITH 3 1/2" SOUND ATTENUATION BLANKET, 5/8" TYPE "X" CYPSUM BOARD (G.W.B.) ONE SIDE, EXTEND WALL TO BOTTOM OF ROOF.

#### **LEGEND**

EXISTING WALLS TO REMAIN ===== EXISTING WALLS TO BE REMOVED

NEW GWB PARTITION







KEY PLAN NO SCALE



Miller & Associates Kearney, NE (308) 234-6456 McCook, NE (308) 345-3710

PLAN BUILDING FLOOR LEXINGTON MUNICIPAL I Ω SE

PIL

LEXINGTON, NEBRASKA

VERIFY SCALES

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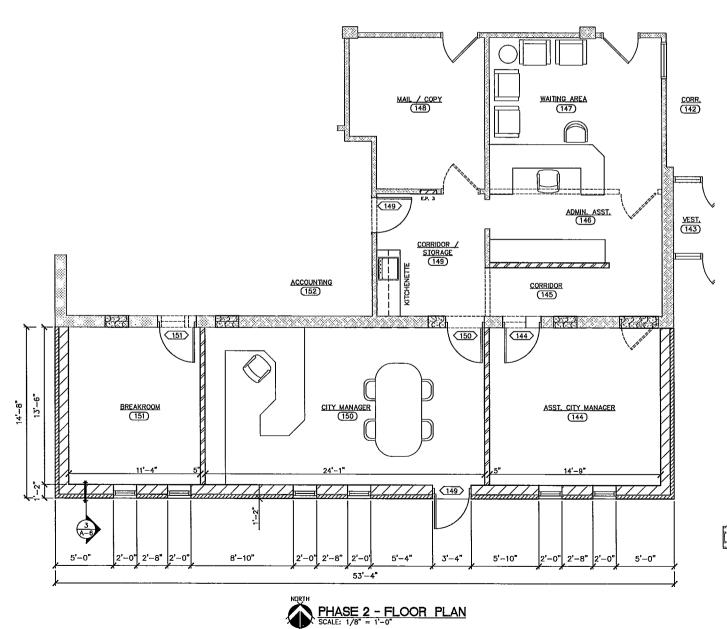
AS NOTED PROJECT NO. 127-G1-098

AUGUST 2007
FIELD BOOK M&A DWG N N/A
DRAWN BY: APRVD BY:

A-1b

FLOOR   BASE				P	ΗA	SE	2	-	RO	O	V	F	INI	SH	ł	SC	가	Ε	Dl	JL	E.					
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146 ADMINISTRATION ASSISTANT 147 WAITING AREA 148 COPY / MAIL 149 CORRIDOR / STORAGE			•	Ţ.	Н	+	+	+	Н	П	Ŧ	П	П	Ŧ	П	Ŧ	П	$\exists$	H	П	8'-0"	Х				
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149 CORRIDOR / STORAGE			H	Н	₩	+1	-1-1	$\vdash$	Н	Н	+	Н	+	+	Н	+	Н		-	Н						 _
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151 BREAK ROOM	151 B	BREAK ROOM		П	П	П	$\blacksquare$	H	П	П	$\perp$	Ц.	П	4	П	1	П		1	П						

	PHASE 2 - DOOR SCHEDULE														
MARK	TYPE	WIDTH	HEIGHT	THICHN'S	FRAME	LABEL	HDWR.	REMARKS							
144	4	3'-0"	7'-0"	1 3/4"	AL #1		1	DETAIL 1, 2, 3							
149 150		3'-0"	7'-0"	1 3/4"											
150		3'-0"	7'-0"	1 3/4"											
151	1	3'-0"	7'-0"	1 3/4"											



#### **GENERAL DEMOLITION NOTES**

CONTRACTOR IS RESPONSIBLE FOR ON-SITE VISITS TO DETERMINE THE ACTUAL CONDITIONS AND EXTENT OF WORK REQUIRED FOR

REVISIONS

Miller & Associates Consulting Engineers, P.C Kearney, NE (308) 234-6456 McCook, NE (308) 345-3710

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PH

NEBRASKA

LEXINGTON,

MUNICIPAL BUILDING

**EXINGTON** SE

ITEMS SCHEDULED FOR DEMOLITION INCLUDE, BUT NOT LIMITED TO: DOORS, WRING, ELECTRICAL FIXTURES, GALVANIZED AND COPPER PIPING AND MECHANICAL EQUIPMENT. ITASH AND DEBRIS SHALL BE REMOVED FROM THE SITE IMMEDIATELY.

#### **DEMOLITION NOTES (KEYED TO PLAN)**

- REMOVE CEILING, METAL STUD AND GPDW WALL SYSTEM AS SHOWN. PATCH AND REPAIR ADJACENT WALLS AND FLOOR. PREPARE SURFACES FOR NEW FINISH. REFER TO FINISH SCHEDULE.
- (2) REMOVE DOOR, FRAME AND HARDWARE COMPLETELY. IN-FILL OPENING WITH NEW 8  $^{\circ}$  CMU.
- (3) CONSTRUCT NEW METAL STUD FRAME WALL AND GPDW SYSTEM AS SHOWN ON DETAIL.
- (4) REMOVE EXISTING BI-PARTING DOORS AND FRAME, IN-FILL OPENING WITH METAL STUDS AND GPDW SYSTEM AS SHOWN, PREPARE SURFACES FOR NEW FINISH, REFER TO FINISH SCHEDULE.
- (5) REMOVE CARPET TO CASEWORK AND INSTALL NEW QUARRY TILE FLOOR FINISH.
- 6 REMOVE DOOR, FRAME AND HARDWARE COMPLETELY.

## **WALL TYPES**

- 5/8" TYPE "X" GYPSUM WALL BOARD ON 3 5/8" METAL STUDS AT 16" O.C., EXTEND TO ROOF STRUCTURE, BUILDING INSULATION, STEEL GIRTS WITH 3 5/6" METAL BACK-UP FOR 7/16" O.S.B. SHEATHING, "TYPEK" AIR FILTRATION BARRIER, AIR SPACE, 4" BRICK VENEER WAINSCOT EXTERIOR.
- B) 3 5/8" METAL STUDS AT 16" O.C. WITH 3 1/2" SOUND ATTENUATION BLANKET, 5/8" TYPE "X" GYPSUM BOARD (G.W.B.) BOTH SIDES, EXTEND WALL TO 3" ABOVE CEILING LINE. SEAL AT PERIMETER AND ALL PENETRATIONS.
- C 3 5/6" METAL STUDS AT 16" O.C. WITH 3 1/2" SOUND ATTENUATION BLANKET, 5/6" TYPE "X" CYPSUM BOARD (G.W.B.) ONE SIDE, EXTEND WALL TO 3" ABOVE CEILING LINE. SEAL AT PERMETER AND ALL PENETRATIONS.
- G.W.B.) EACH SIDE AT 16" O.C., 5/8" TYPE "X" GYPSUM WALL BOARD (G.W.B.) EACH SIDE. PARTITION TO EXTEND TO BOTTOM OF STEEL ROOF PURLINS. SEAL AT PERIMETERS AND PENETRATIONS. (1 HOUR RATED, UL DES.)
- B) 3 5/8" METAL STUDS AT 16" O.C., 5/8" TYPE "X" GYPSUM WALL BOARD (G.W.B.) EACH SDE. ONE SIDE TO EXTEND TO BOTTOM OF SEAL STEEL ROOF PURLUNS, OTHER SIDE TO BOTTOM OF BEAM TSECOND FLOOR, SEAL AT PERIMETERS AND PENETRATIONS.

#### **LEGEND**

EXISTING WALLS TO REMAIN ===== EXISTING WALLS TO BE REMOVED

NEW CMU

NEW GWB PARTITION

--- DOOR DESIGNATION



VERIFY SCALES

BAR IS ONE INCH ON ORIGINAL DRAWING


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AS NOTED PROJECT NO. 127-G1-098

AUGUST 2007
FIELD BOOK M&A DWG NO N/A
DRAWN BY: APRVD BY: A-2

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ROOM NO.		SEALED CONCRETE	/INT	4" VINY	NONE		PAINTED SCO	OR	TH	S	601	W.	ALI	LS EA	ST			ES	ŠT	PAINTED		.1 N	g	CEILING HEIGHT	REMARKS
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	INSPECTION	H	+	Н	+	Н	+	+	╀	Н	Н	+	+	+	Н	$\dashv$	+	╁	+	╀	Н	$\vdash$	+		
158	OFFICE	++	+-	H	+	╁	╁	+	╅	Н	Н	+	+	+	Н	$\dashv$	+	$^{+}$	+	t	Н	H	╅		<del> </del>
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	PHASE 3 - DOOR SCHEDULE														
MARK	TYPE	WIDTH	HE I GHT	TH1CHN'S	FRAME	LABEL	HDWR,		REMARKS						
157	1	3'-0"	7'-0"	1 3/4"	AL #1		1	DETAIL 1, 2, 3							
158	1	3'-0"	7'-0"	1 3/4"	AL. #2		2		•						
159				i i											



#### GENERAL DEMOLITION NOTES
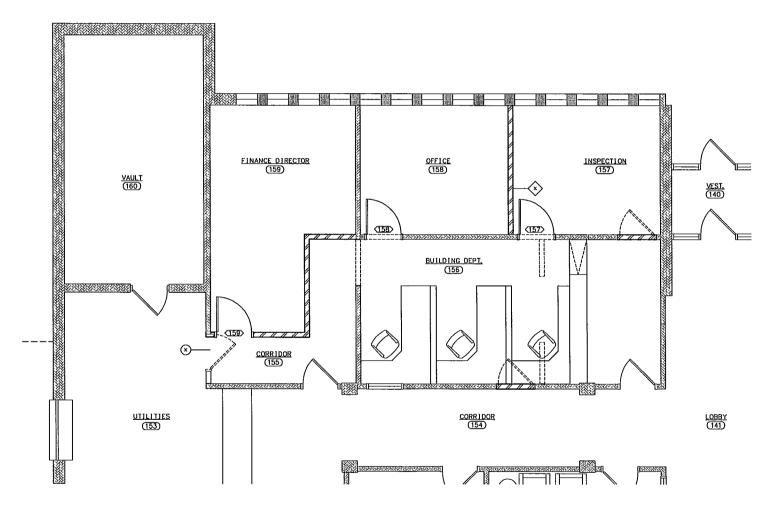
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ANY DAMAGE TO THE PROPERTY, WHICH IS TO REMAIN IN USE, SHALL BE REPAIRED WITHOUT ADDITIONAL EXPENSE TO THE OWNER.

ITEMS SCHEDULED FOR DEMOLITION INCLUDE, BUT NOT LIMITED TO: DOORS, WIRING, ELECTRICAL FIXTURES, GALVANIZED AND COPPER PIPING AND MECHANICAL EQUIPMENT. TRASH AND DEBRIS SHALL BE REMOVED FROM THE SITE IMMEDIATELY.

## **DEMOLITION NOTES (KEYED TO PLAN)**

- (1) REMOVE CEILING, METAL STUD AND GPDW WALL SYSTEM AS SHOWN. PATCH AND REPAIR ADJACENT WALLS AND FLOOR. PREPARE SURFACES FOR NEW FINISH. REFER TO FINISH SCHEDULE.
- 2 REMOVE DOOR, FRAME AND HARDWARE COMPLETELY. IN-FILL OPENING WITH NEW 8" CMU.
- (3) CONSTRUCT NEW METAL STUD FRAME WALL AND GPDW SYSTEM AS SHOWN ON DETAIL.
- 4 REMOVE EXISTING BI-PARTING DOORS AND FRAME. IN-FILL OPENING WITH METAL STUDS AND GPOW SYSTEM AS SHOWN. PREPARE SURFACES FOR NEW FINISH. REFER TO FINISH SCHEDULE.
- (5) REMOVE CARPET TO CASEWORK AND INSTALL NEW QUARRY TILE FLOOR FINISH.
- 6 REMOVE DOOR, FRAME AND HARDWARE COMPLETELY.


## WALL TYPES


- 5/8" TYPE "X" GYPSUM WALL BOARD ON 3 5/8" METAL STUDS AT 16" O.C., EXTEND TO ROOF STRUCTURE, BUILDING INSULATION, STEEL GIRTS WITH 3 5/8" METAL BACK—UP FOR 7/16" O.S.B. SHEATHING, "TYPKE" AIR FILIRATION BARRIER, AIR SPACE, 4" BRICK VENEER WAINSCOT EXTERIOR.
- B) 3 5/8" METAL STUDS AT 16" O.C. WITH 3 1/2" SOUND ATTENUATION BLANKET, 5/8" TYPE "X" GYPSUM BOARD (G.W.B.) BOTH SIDES, EXTEND WALL TO 3" ABOVE CEILING LINE. SEAL AT PERIMETER AND ALL PENETRATIONS.
- 5/8" METAL STUDS AT 16" O.C. WITH 3 1/2" SOUND
  ATTENUATION BLANKET, 5/8" TYPE "X" GYPSUM BOARD (G.W.B.)
  ONE SIDE, EXTEND WALL TO 3" ABOVE CEILING LINE. SEAL AT
  PERIMETER AND ALL PENETRATIONS.
- 6" METAL STUDS AT 16" O.C., 5/8" TYPE "X" GYPSUM WALL BOARD (G.W.B.) EACH SIDE. PARTITION TO EXTEND TO BOTTOM OF STEEL ROOF PURLINS. SEAL AT PERIMETERS AND PENETRATIONS. ( 1 HOUR RATED, UL DES.)
- TE 3 5/8" METAL STUDS AT 16" O.C., 5/8" TYPE "X" GYPSUM WALL BOARD (G.W.B.) EACH SIDE. ONE SIDE TO EXTEND TO BOTTOM OF STEL ROOF PURILINS, OTHER SIDE TO BOTTOM OF BEAM AT SECOND FLOOR. SEAL AT PERIMETERS AND PENETRATIONS.

#### LEGEND

LLGLIID	
*****	EXISTING WALLS TO REMAIN
======	EXISTING WALLS TO BE REMOVE
<b>******</b>	NEW CMU
	NEW GWB PARTITION
$\neg \vdash$	EXISTING DOOR TO REMAIN
	EXISTING DOOR & FRAME TO BE REMOVED
	NEW DOOD & FOALE

DOOR DESIGNATION

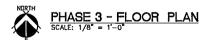

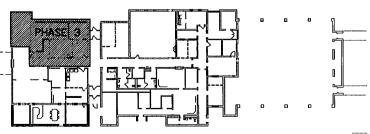

KEY PLAN NO SCALE REVISIONS BY

&.

Miller & Associates Consulting Engineers, P.C Kearney, NE (308) 234-6456 McCook, NE (308) 345-3710

LEXINGTON MUNICIPAL BUILDING
PHASE 3 - FLOOR PLAN
LEXINGTON, NEBRASKA

VERIFY SCALES


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IF NOT ONE INCH ON THIS SHEET, ADJUST SCALES ACCORDINGLY.

AS NOTED
PROJECT NO.
127-G1-098
DATE:

AUGUST 2007
FIELD BOOK M&A DWG NO.
N/A
DRAWN BY: APRVD BY:
SHEET OF

OCT 14, 2008 \* 12:13:56 Location

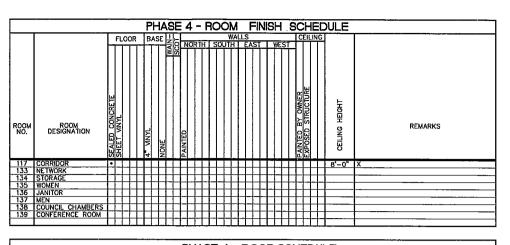

L							PH/	4SE 4	- DOOR SCHEDULE
MA	RK	TYPE	WIDTH	HEIGHT	THICHN'S	FRAME	LABEL	HDWR.	REMARKS
13	3	1	3'-0"	7'-0"	1 3/4"	AL #1		1	DETAIL 1, 2, 3
13			3'-0"	7'-0"	1 3/4"		I		
13									
13	9								

## **GENERAL DEMOLITION NOTES**

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## **DEMOLITION NOTES (KEYED TO PLAN)**

- REMOVE CEILING, METAL STUD AND GPDW WALL SYSTEM AS SHOWN. PATCH AND REPAIR ADJACENT WALLS AND FLOOR, PREPARE SURFACES FOR NEW FINISH. REFER TO FINISH SCHEDULE.
- REMOVE DOOR, FRAME AND HARDWARE COMPLETELY. IN-FILL OPENING WITH NEW 8" CMU.
- $\stackrel{\textstyle \Longleftrightarrow}{\Longrightarrow}$  construct new metal stud frame wall and gPDW system as shown on Detail.
- ARMOVE EXISTING BI-PARTING DOORS AND FRAME, IN-FILL OPENING WITH METAL STUDS AND GROW SYSTEM AS SHOWN, PREPARE SURFACES FOR NEW FINISH, REFER TO FINISH SCHEDULE.
- 5 REMOVE CARPET TO CASEWORK AND INSTALL NEW QUARRY TILE FLOOR FINISH.
- 6 REMOVE DOOR, FRAME AND HARDWARE COMPLETELY.

## **WALL TYPES**

(138A)

COUNCIL CHAMBERS
(138)

- 5/8" TYPE "X" GYPSUM WALL BOARD ON 3 5/8" METAL STUDS AT 16" O.C., EXTEND TO ROOF STRUCTURE, BUILDING INSULATION, STEEL GRTS WTH 3 5/8" METAL BACK-UP FOR 7/16" O.S.B. SHEATHING, "TYVEK" AIR FILTRATION BARRIER, AIR SPACE, 4" BRICK VENEER WAINSCOT EXTERIOR.
- B) 3 5/8" METAL STUDS AT 16" O.C. WITH 3 1/2" SOUND ATTENUATION BLANKET, 5/8" TYPE "X" GYPSUM BOARD (G.W.B.) BOTH SIDES, EXTEND WALL TO 3" ABOVE CEILING LINE. SEAL AT PERIMETER AND ALL PENETRATIONS.
- Type "x" Gypsum Board (G.W.B.) ONE SIDE, EXTEND WALL TO 3" ABOVE CEILING LINE.


  SEAL AT PERIMETER AND ALL PENETRATIONS.
- 6 SIDE. PARTILISUS AT 16" O.C., 5/8" TYPE "X" CYPSUM WALL BOARD (G.W.B.) EACH SIDE. PARTITION TO EXTEND TO BOTTOM OF STEEL ROOF PURLINS. SEAL AT PERIMETERS AND PENETRATIONS. (1 HOUR RATED, UL DES.)
- E 3 5/8" METAL STUDS AT 16" O.C., 5/8" TYPE "X" GYPSUM WALL BOARD (G.W.B.) EACH SIDE. ONE SIDE TO EXTEND TO BOTTOM OF STEEL ROOF PURLINS, OTHER SIDE TO BOTTOM OF BEAM AT SECOND FLOOR. SEAL AT PERIMETERS AND PENETRATIONS.

## **LEGEND**

EXISTING WALLS TO REMAIN ===== EXISTING WALLS TO BE REMOVED NEW GWB PARTITION EXISTING DOOR TO REMAIN

===== NEW DOOR & FRAME

-----DOOR DESIGNATION

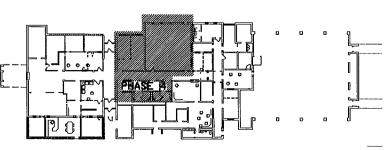

KEY PLAN NO SCALE

LEXINGTON MUNICIPAL 4 S 4 PH

REVISIONS

Miller & Associates Consulting Engineers, P.C Kearney, NE (308) 234-6456 McCook, NE (308) 345-3710

Z

PL

FLOOR

LEXINGTON, NEBRASKA

BUILDING

VERIFY SCALES

BAR IS ONE INCH ON ORIGINAL DRAWING F NOT ONE INCH ON THIS SHEET, ADJUST SCALES ACCORDINGLY.

AS NOTED PROJECT NO. 127-G1-098

AUGUST 2007
FIELD BOOK M&A DWG NO N/A
DRAWN BY: APRVD BY: SHEET

PHASE 4 - FLOOR PLAN
SCALE: 1/8" = 1'-0"

0:

CORRIDOR (117)

JAN. (136)

MEN (137)

(139)

WOMEN (135)

CONFERENCE ROOM

 $\otimes$ 

STORAGE (134)

(133)

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