Q005148 - CITY OF LEXINGTON - LEXINGTON LOT 3

1721 SQ. FT.



DEALER

BONNAVILLA HOMES 111 GRANT STREET P.O. BOX 127 AURORA, NE 68818 402.694.5250

CUSTOMER

LEXINTON LOT 3 LEXINGTON, NE

SHEET LIST

NO SHEET NAME

00 COVER SHEET

00B BROCHURE

01 MAIN FLOOR PLAN

08 ELECTRICAL PLAN


09 EXTERIOR ELEVATIONS

14 FOUNDATION PLAN

15A CABINET DETAILS

15B CABINET DETAILS

BUILDING SECTION

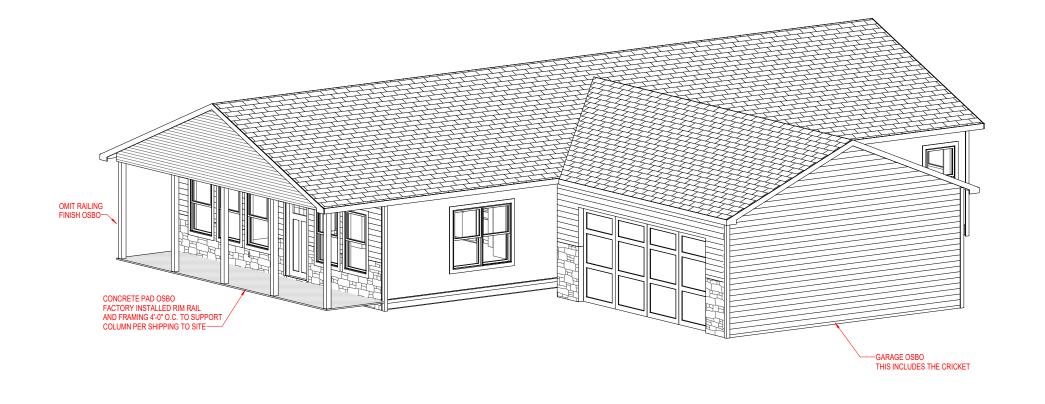


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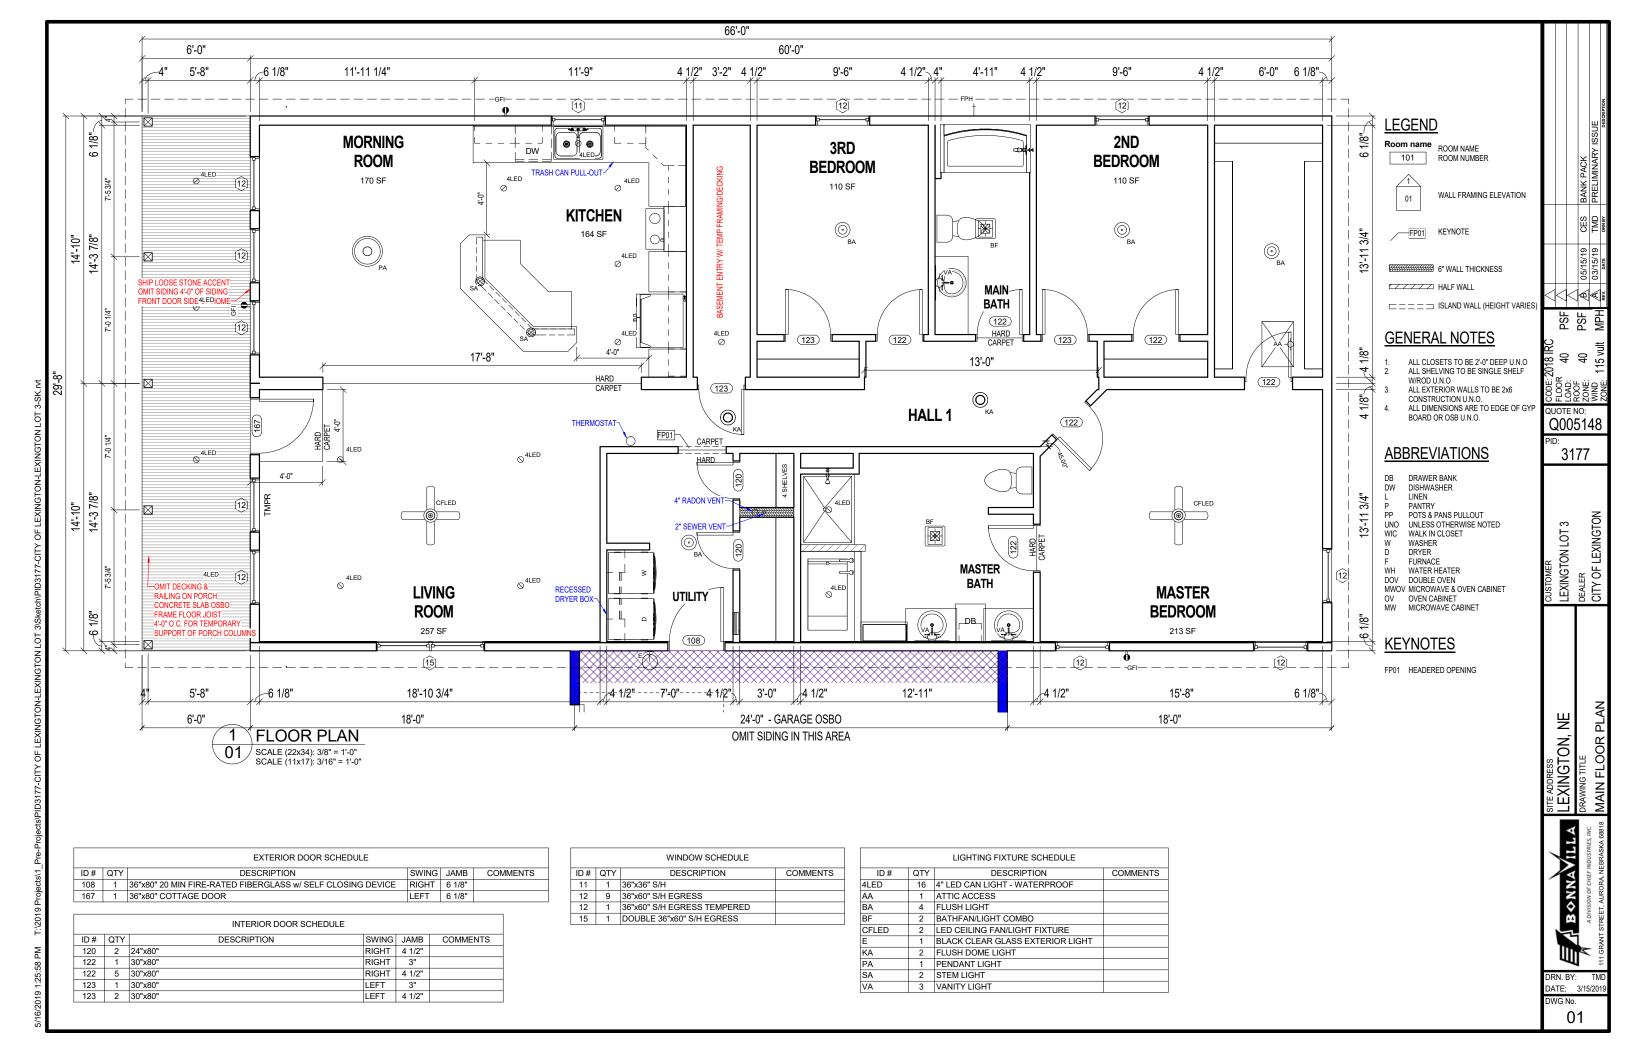
THESE DRAWINGS AND THE DESIGN SHOWN HAVE BEEN PREPARED FOR THIS SPECIFIC PROJECT AS AN INSTRUMENT OF SERVICE AND SHALL REMAIN THE SOLE PROPERTY OF BONNAVILLA HOMES AND THEIR CONSULTANTS. ANY REPRODUCTION, COPYING OR USE OTHER THAN FOR THIS SPECIFIC PROJECT IS PROHIBITED WITHOUT THE PRIOR WRITTEN CONSULTANTS. ANY REPRODUCTION, COPYING OR USE OTHER THAN FOR THIS SPECIFIC PROJECT IS PROHIBITED WITHOUT THE PRIOR WRITTEN CONSULTANTS. ANY REPRODUCTION, COPYING OR USE OTHER THAN FOR THIS SPECIFIC PROJECT IS PROHIBITED WITHOUT THE PRIOR WRITTEN CONSULTANTS. ANY REPRODUCTION, COPYING OR USE OTHER THAN FOR THIS SPECIFIC PROJECT IS PROHIBITED WITHOUT THE PRIOR WRITTEN CONSULTANTS. ANY REPRODUCTION, COPYING OR USE OTHER THAN FOR THIS SPECIFIC PROJECT IS PROHIBITED WITHOUT THE PRIOR WRITTEN CONSULTANTS. ANY REPRODUCTION, COPYING OR USE OTHER THAN FOR THIS SPECIFIC PROJECT IS PROHIBITED WITHOUT THE PRIOR WRITTEN CONSULTANTS. ANY REPRODUCTION, COPYING OR USE OTHER THAN FOR THIS SPECIFIC PROJECT IS PROHIBITED WITHOUT THE PRIOR WRITTEN CONSULTANTS. ANY REPRODUCTION, COPYING OR USE OTHER THAN FOR THIS SPECIFIC PROJECT IS PROHIBITED WITHOUT THE PRIOR WRITTEN CONSULTANTS. ANY REPRODUCTION, COPYING OR USE OTHER THAN FOR THIS SPECIFIC PROJECT IS PROHIBITED WITHOUT THE PRIOR WRITTEN CONSULTANTS. ANY REPRODUCTION, COPYING OR USE OTHER THAN FOR THIS SPECIFIC PROJECT IS PROHIBITED WITHOUT THE PRIOR WRITTEN CONSULTANTS. ANY REPRODUCTION, COPYING OR USE OTHER THAN FOR THE PROPERTY OF THE P

THE CYPRESS XL

29'-8" X 66'-0"



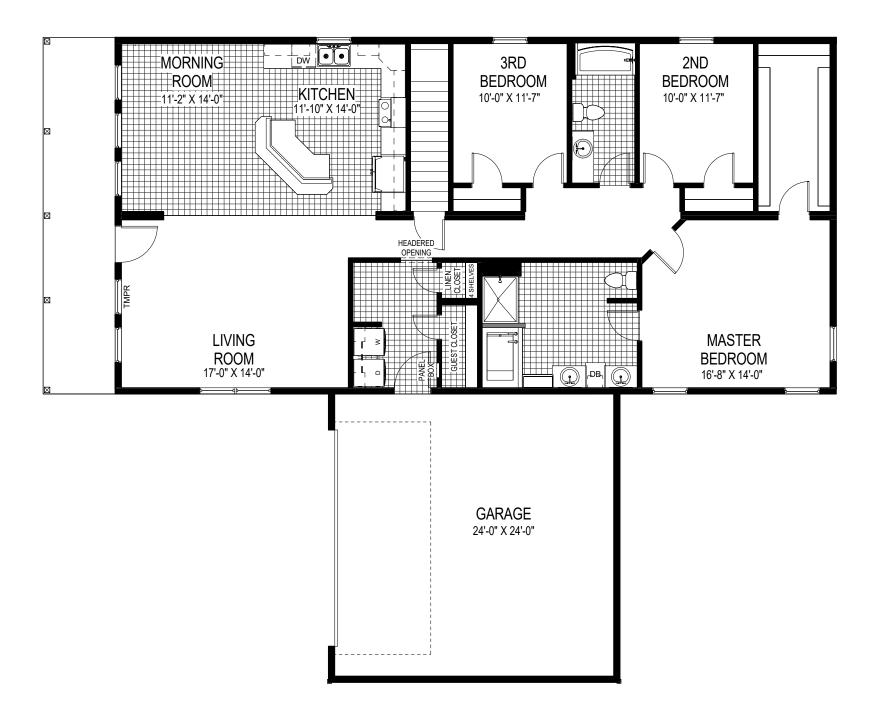





RECEP ABOVE CABINET FOR UNDER CABINET LIGHTING

ELECTRICAL LEGEND

INTERIOR DUPLEX RECEPT

INTERIOR SINGLE RECEPT

PGFI EXTERIOR GROUND FAULT DUPLEX RECEPT

EXTERIOR DUPLEX RECEPT

☐ FLOOR DUPLEX RECEPT GGFI SOFFIT GROUND FAULT DUPLEX RECEPT

ELECTRIC RANGE RECEPT

DRYER RECEPT

220 OUTLET

THERMOSTAT

SMOKE DETECTOR MOKE-CO DETECTOR SWITCH

3-WAY SWITCH RHEOSTAT

3-WAY RHEOSTAT TIMER SWITCH

PANEL BOX ✓ JACK SYMBOL FOR TV, PH, CA5, WPH


TV CABLE JACK PH PHONE JACK


CA5 DATA JACK WPH WALL PHONE JACK

ELECTRICAL NOTES


- ALL 125-VOLT, 15 & 20 AMP. RECEPTACLES SHALL BE LISTED TAMPER-RESISTANT RECEPTACLES. OUTDOOR RECEPTACLES EQUIPPED WITH IN USE WEATHER PROOF COVERS.
- ALL RECEPTACLE AND SWITCH LOCATIONS ARE TYPICAL HEIGHT U.N.O.
 NO AMP CONNECTORS - ALL CONNECTIONS MUST BE
- MADE IN BOX.
 LIGHTS WITH DIMENSIONS WILL BE LOCATED IN
- DROPPED CEILINGS.


 EXTERIOR LIGHTS ARE TO BE LISTED FOR WET LOCATIONS.

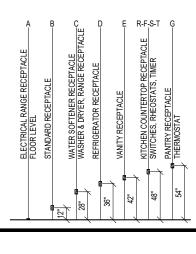

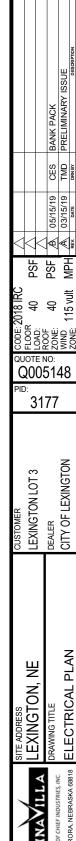

DATE: 3/15/201 80

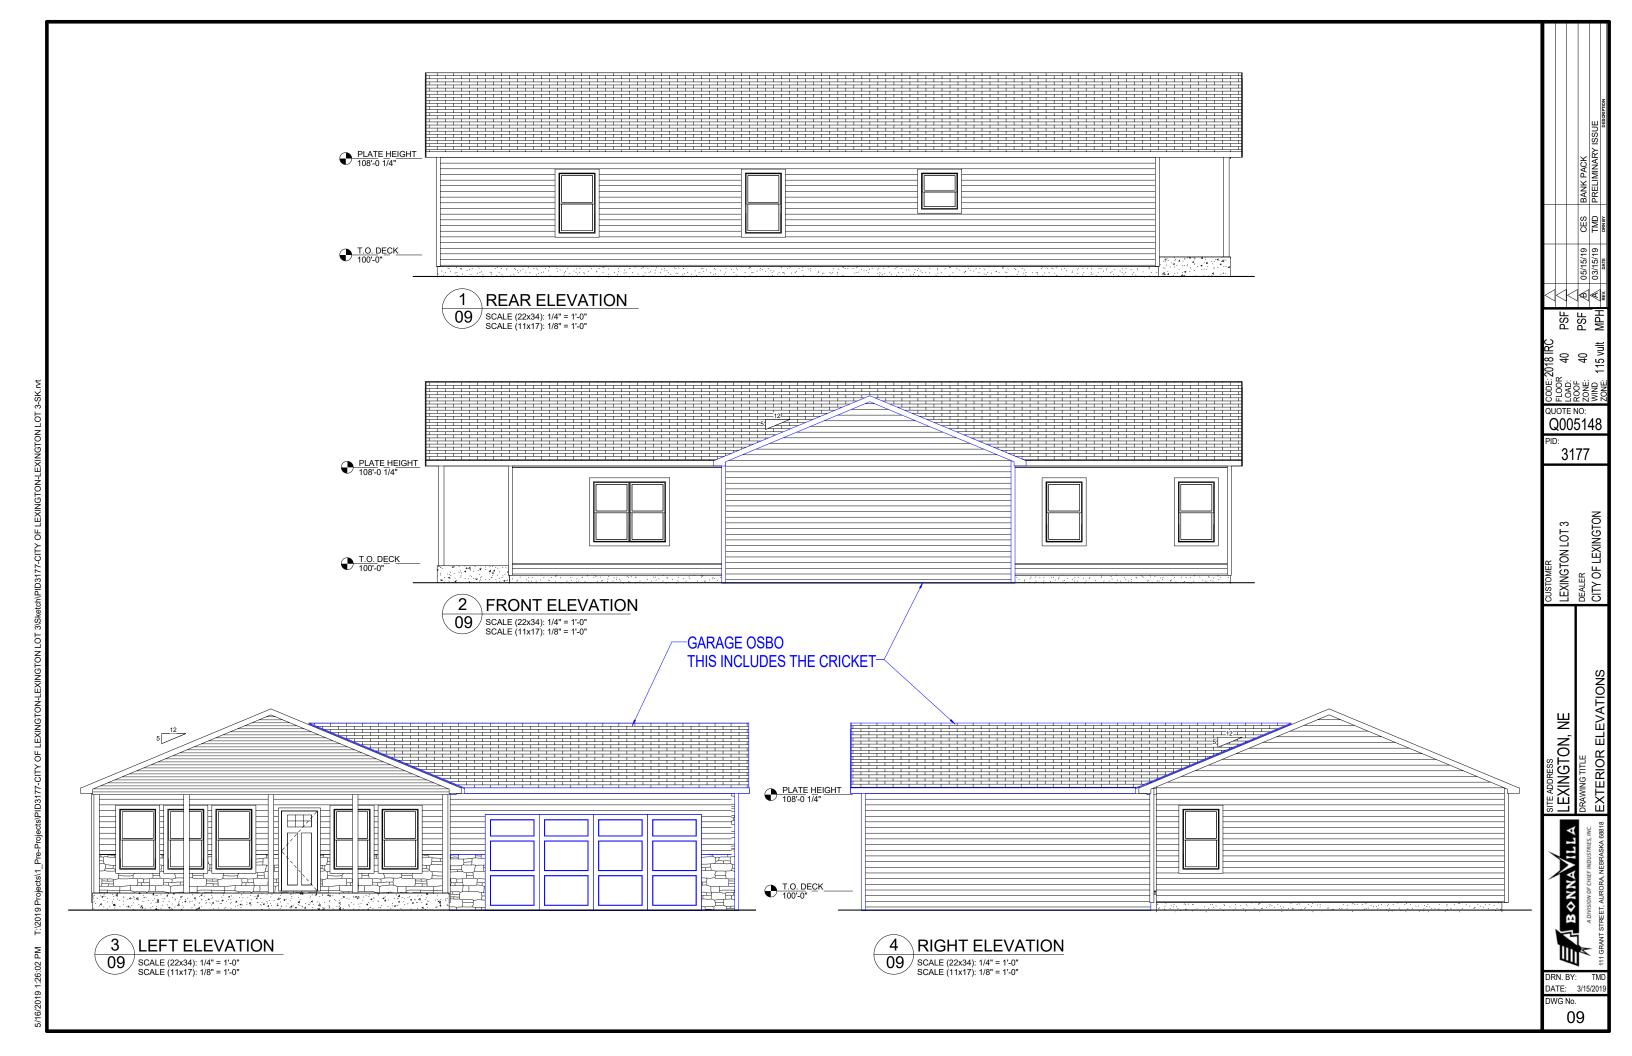

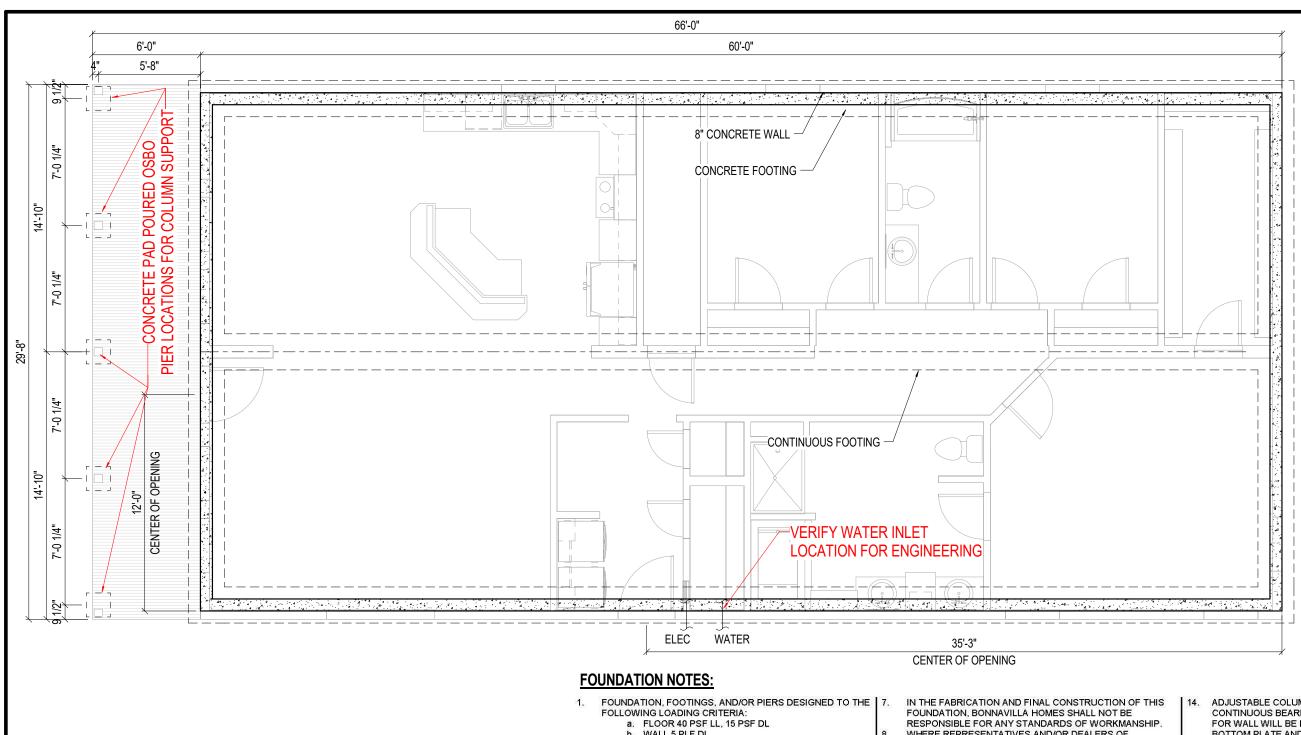

WALL 5 PLF DL

FOUNDATION PLAN

14 SCALE (22x34): 3/8" = 1'-0" SCALE (11x17): 3/16" = 1'-0"

ROOF 40 PSF LL, 15 PSF DL

FOR CRAWLSPACE APPLICATION, THE MINIMUM NET AREA OF VENTILATION OPENINGS FOR UNDER-FLOOR VENTILATION SHALL MEET THE MINIMUM REQUIREMENTS OF THE APPLICABLE BUILDING CODES (OR LOCAL REQUIREMENTS IF MORE STRINGENT).

FOUNDATION ACCESS SHALL BE DETERMINED, LOCATED, VERIFIED, AND INSTALLED IN FIELD, BY OTHERS TO THE APPLICABLE BUILDING CODES.

THE RIM JOIST ALONG THE MARRIAGE LINE CONSISTS OF 1-1/2" x 11-7/8" LAMINATED BEAMS. PROVIDE SUPPORTS PIERS ALONG THE MARRIAGE LINE 2-3/4" SHORTER THAN PERIMETER SUPPORTS. (NOT APPLICABLE WITH TRUSS

THE HOME SHALL BE GROUNDED AS DEFINED IN ARTICLE 250, SECTION III, OF THE 2014 NATIONAL ELECTRICAL CODE AS PART OF THOSE REQUIREMENTS, A FOOTING/FOUNDATION REBAR SHALL BE LEFT EXPOSED SO A CONNECTION CAN BE MADE WITH THE BUILDING STRUCTURE, AS DEFINED IN NEC ARTICLE 250, SECTION III,

BONNAVILLA HOMES SHALL NOT BE IN ANY WAY RESPONSIBLE FOR THE QUALITY OF THE QUANTITY OF MATERIALS USED (OR NOT USED)

WHERE REPRESENTATIVES AND/OR DEALERS OF BONNAVILLA HOMES ARE ACTING AS INDEPENDENT CONTRACTORS, THEY DO SO AS THEIR OWN REPRESENTATIVE.

IT IS THE RESPONSIBILITY OF THE HOMEOWNER AND/OR FOUNDATION CONTRACTOR TO MEET ALL ELECTRICAL, MECHANICAL, ENERGY, AND BUILDING CODES WHICH MAY APPLY TO THIS FOUNDATION PLAN.

CRAWLSPACE FOUNDATIONS REQUIRE AN ACCESS MEETING THE REQUIREMENTS OF THE IBC SECTION R408 ACCESS OPENING TO BE 16" x 24". WHEN ACCESS IS LOCATED BELOW GRADE, AN AREAWAY OF 16" x 24" SHALL BE PROVIDED DIRECTLY IN FRONT OF THE ACCESS. AREAWAY SHALL BEGIN BELOW THE LEVEL OF THE CRAWLSPACE ACCESS. ACCESSES SHALL NOT BE LOCATED BENEATH A DOOR OF THE UPPER STORY. FOUNDATIN ACCESS SHALL BE DETERMINED, LOCATED,

VERIFIED, AND INSTALLED IN FIELD, BY OTHER VERIFY LOCATION, SIZE, AND QUALITY OF EXTERIOR

WINDOWS. FOOTINGS WIDTH AND DEPTH - FOOTINGS ARE TO BE CALCULATED BY AN ARCHITECT OR ENGINEER BASED ON HOME DESIGN. TYPICAL SPECIFICATIONS FOR PERIMETER FOOTINGS IS 16" x 8". CENTERLINE FOOTING DIMENSION IS 16" WIDE AND 16" DEEP. THESE DIMENSIONS ARE TYPICAL AND ARE AFFECTED BY SOIL TYPE, SOIL COMPACTION,

SPECIAL LOADS, ETC

ADJUSTABLE COLUMN SUPPORTS MAY BE REPLACED WITH CONTINUOUS BEARING WALL (MINIMUM REQUIREMENTS FOR WALL WILL BE DOUBLE 2 x 4 TOP PLATE, SINGLE 2 x 4 BOTTOM PLATE AND DOUBLE 2 x 4 STUDS @ 16" O.C. OR DOUBLE 2 x 6 TOP PLATE, SINGLE 2 x 6 BOTTOM PLATE AND SINGLE 2 x 6 STUDS @ 16' O.C.

FOUNDATION ENGINEER TO PROVIDE LOAD PATH FOR UPLIFT FORCES FROM SHEARWALLS TO FOUNDATION (i.e. HOLDOWNS, STRAPPING, ETC.). SUGGESTED DESIGN LOADS TO BE EQUAL TO CAPACITY OF HOLDOWN. (i.e. SIMPSON LSTHD8RJ = 3115# UPLIFT).


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NOTE: ***THE POINT LOADS THAT ARE SHOWN ON THIS FOUNDATION DRAWING ARE ESTIMATED VALUES. THESE VALUES COULD CHANGE WHEN THE HOME IS ENGINEERED. THESE ESTIMATED VALUES SHOULD NOT BE USED TO SIZE FOOTINGS. THE COMPLETE FOUNDATION DESIGN IS NOT THE **RESPONSIBILITY OF BONNAVILLA HOMES.*****

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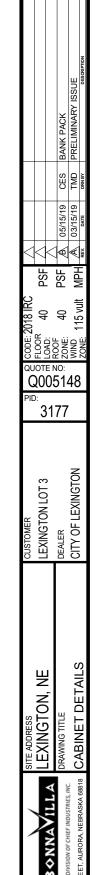







				CABINE	T SCHE	DULE -	KITCH	EN					
				DC	OOR					DRA	WER		
QTY	CABINET	9 3/4x27	9x21	9x39	12x21	12x39	15x21	15x39	9x6	12x6	15x6	24x6	COMMENTS
1	3/4" B FILL												
1	3/4" H FILL												
2	B15				1					1			
3	B18						1				1		
3	B27				2							1	
1	B36KS						2				2		
1	B3636LS	2											
1	H2742AC							1					
1	H3026MW				2								
1	H3825						2						
2	H184212							1					
1	H214212			2									
3	H274212					2							

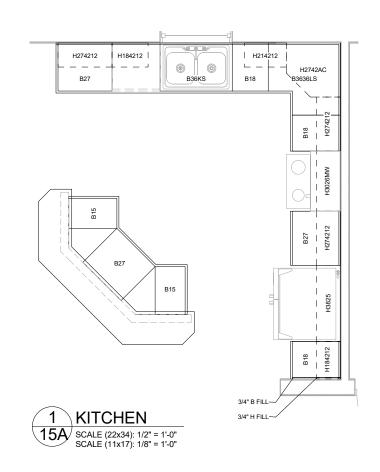	CABINET LIST	Г
QTY	CABINET	COMMENTS
1	3/4" B FILL	
1	3/4" H FILL	
3	21 x 33 MIRROR	
2	B15	
3	B18	
3	B27	
1	B36KS	
1	B3636LS	
1	BB30 CUBBY BENCH	
2	BB33	
1	BBD18T	
1	H1542 CUBBY	
1	H2742AC	
1	H3026MW	
1	H3825	
2	H184212	
1	H214212	
3	H274212	
1	V18	
1	V33	
1	WD30	




BONNAVILLA

DWG No. 15A

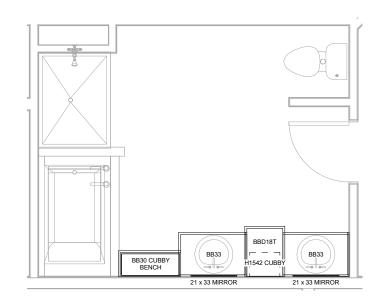




	CABINET SCHI	EDULE	- MAST	ER BA	ATH	
		DO	OR	DRA	WER	
QTY	CABINET	12x27	15x27	15x6	15x12	COMMENTS
2	21 x 33 MIRROR					
1	BB30 CUBBY BENCH					
2	BB33		2			
1	BBD18T			3	1	
1	H1542 CUBBY	1				

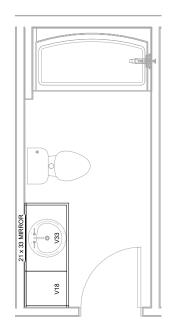




	CABINET SCHED	ULE - MAIN	BATH
		DOOR	
QTY	CABINET	15x21	COMMENTS
1	21 x 33 MIRROR		
1	V18	1	
1	V33	2	


CABINET LIST						
QΤΥ	CABINET	COMMENTS				
1	3/4" B FILL					
1	3/4" H FILL					
3	21 x 33 MIRROR					
2	B15					
3	B18					
3	B27					
1	B36KS					
1	B3636LS					
1	BB30 CUBBY BENCH					
2	BB33					
1	BBD18T					
1	H1542 CUBBY					
1	H2742AC					
1	H3026MW					
1	H3825					
2	H184212					
1	H214212					
3	H274212					
1	V18					
1	V33					
1	WD30					

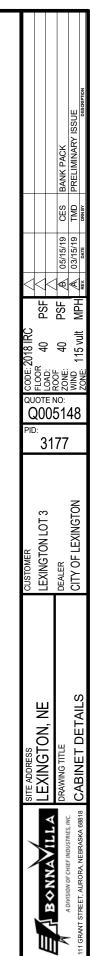


15B

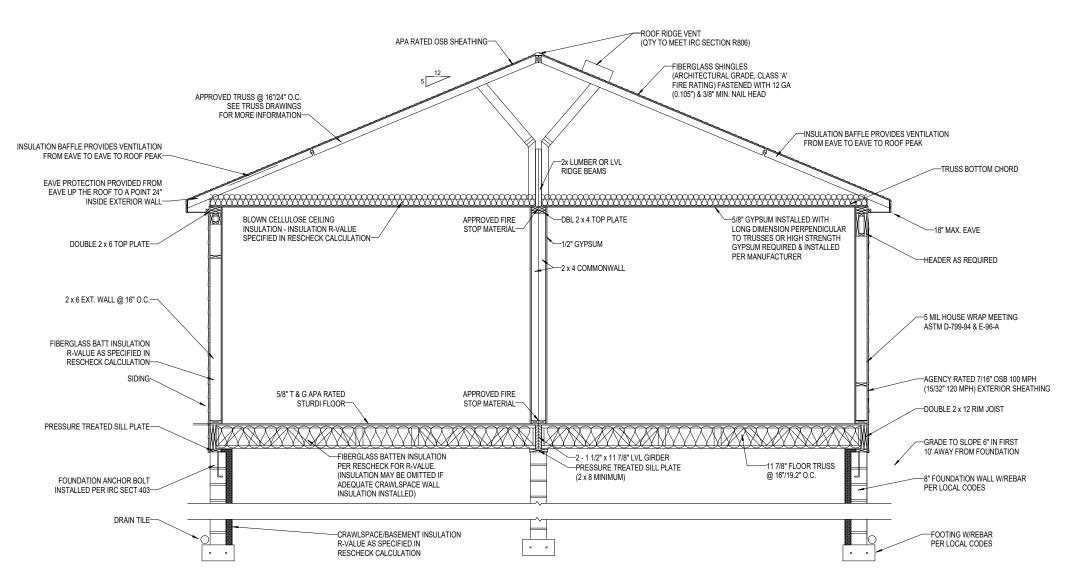

CROSS SECTION: WITH FLOOR TRUSS

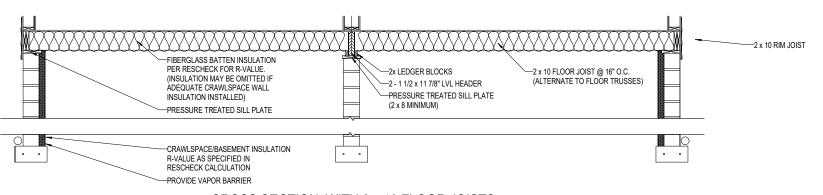

CROSS SECTION: WITH 2 x 10 FLOOR JOISTS

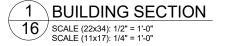

NOTI

WHEN A CRAWLSPACE IS USED IN LIEW OF A BASEMENT FOUNDATION, CONSTRUCTION OF CRAWLSPACE SHALL BE SPECIFIED IN THE INTERNATIONAL RESIDENTIAL CODE CHAPTER 4

NOTE

THE HOME SHOULD BE GROUNDED AS DEFINED IN ARTICLE 250, SECTION III, OF THE NATIONAL ELECTRICAL CODE. AS PART OF THOSE REQUIREMENTS, A FOOTING REBAR SHALL BE LEFT EXPOSED SO A CONNECTION CAN BE MADE WITH THE BUILDING STRUCTURE, AS DEFINED IN NEC ARTICLE 250, SECTION III, PART 50.

