

LEGEND	
	PROPOSED 4" SIDEWALK
	PROPOSED 6" CONCRETE PAVEMENT
	PROPOSED SUPPORT FACILITY BUILDING
	PROPOSED WATER SERVICE EXTENSION
	PROPOSED SANITARY SEWER
	PROPOSED 5 FT. CHAIN LINK FENCE

INSTALL:
SILT FENCE - 2 LOCATIONS

APPROXIMATE
LOCATION OF
GEOTHERMAL
WELL LOOPS
(BY OWNER)

CONTRACTOR SHALL INSTALL AND MAINTAIN ALL NECESSARY SEDIMENT AND EROSION CONTROL DEVICES TO PROTECT AGAINST POLLUTION WITHIN THE CONSTRUCTION LIMITS AND ANY OFF-SITE AREAS, IF REQUIRED.

REVISIONS	BY

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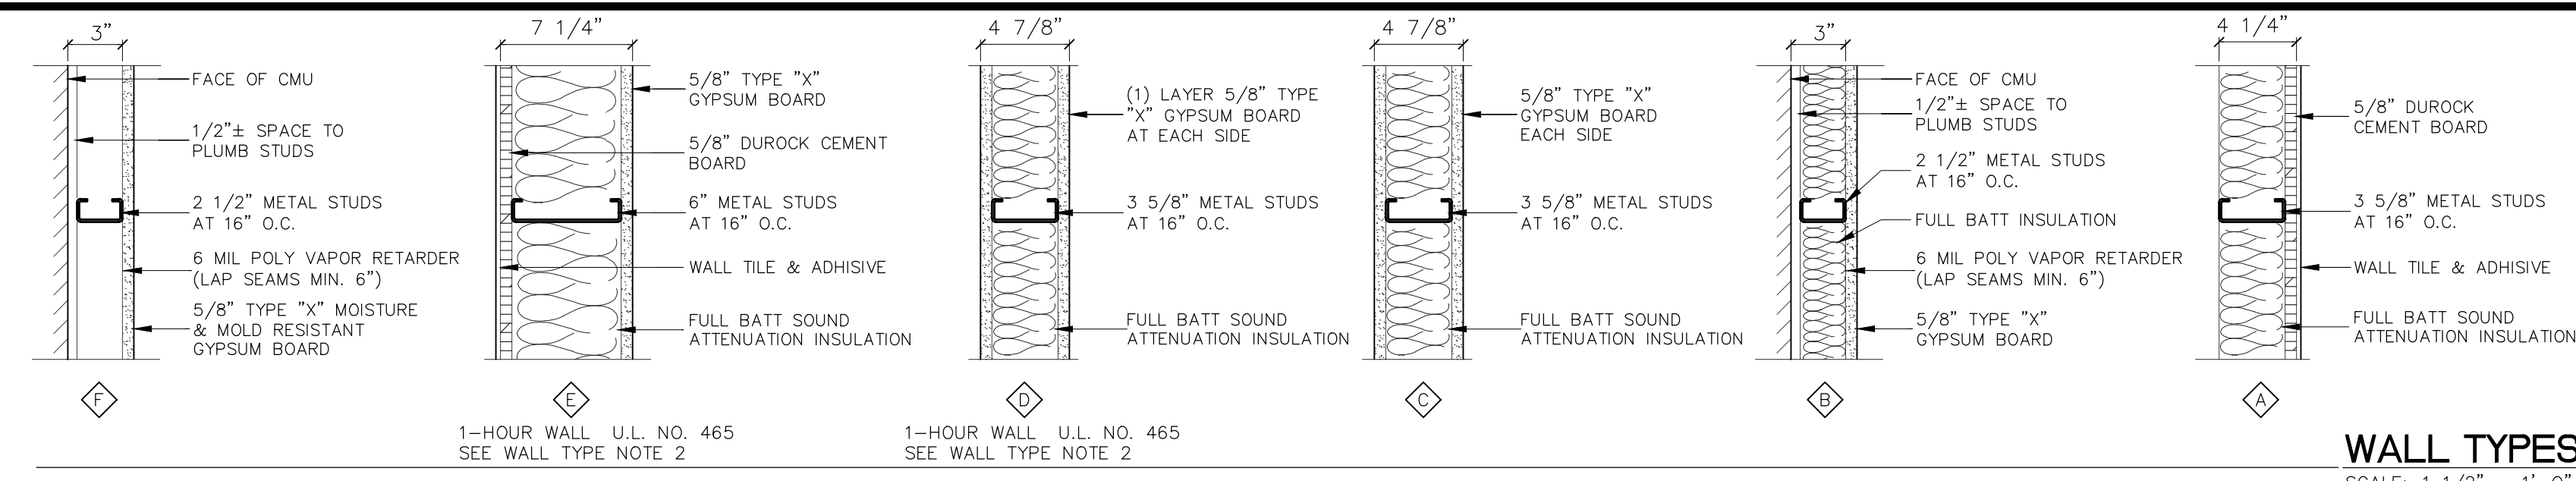
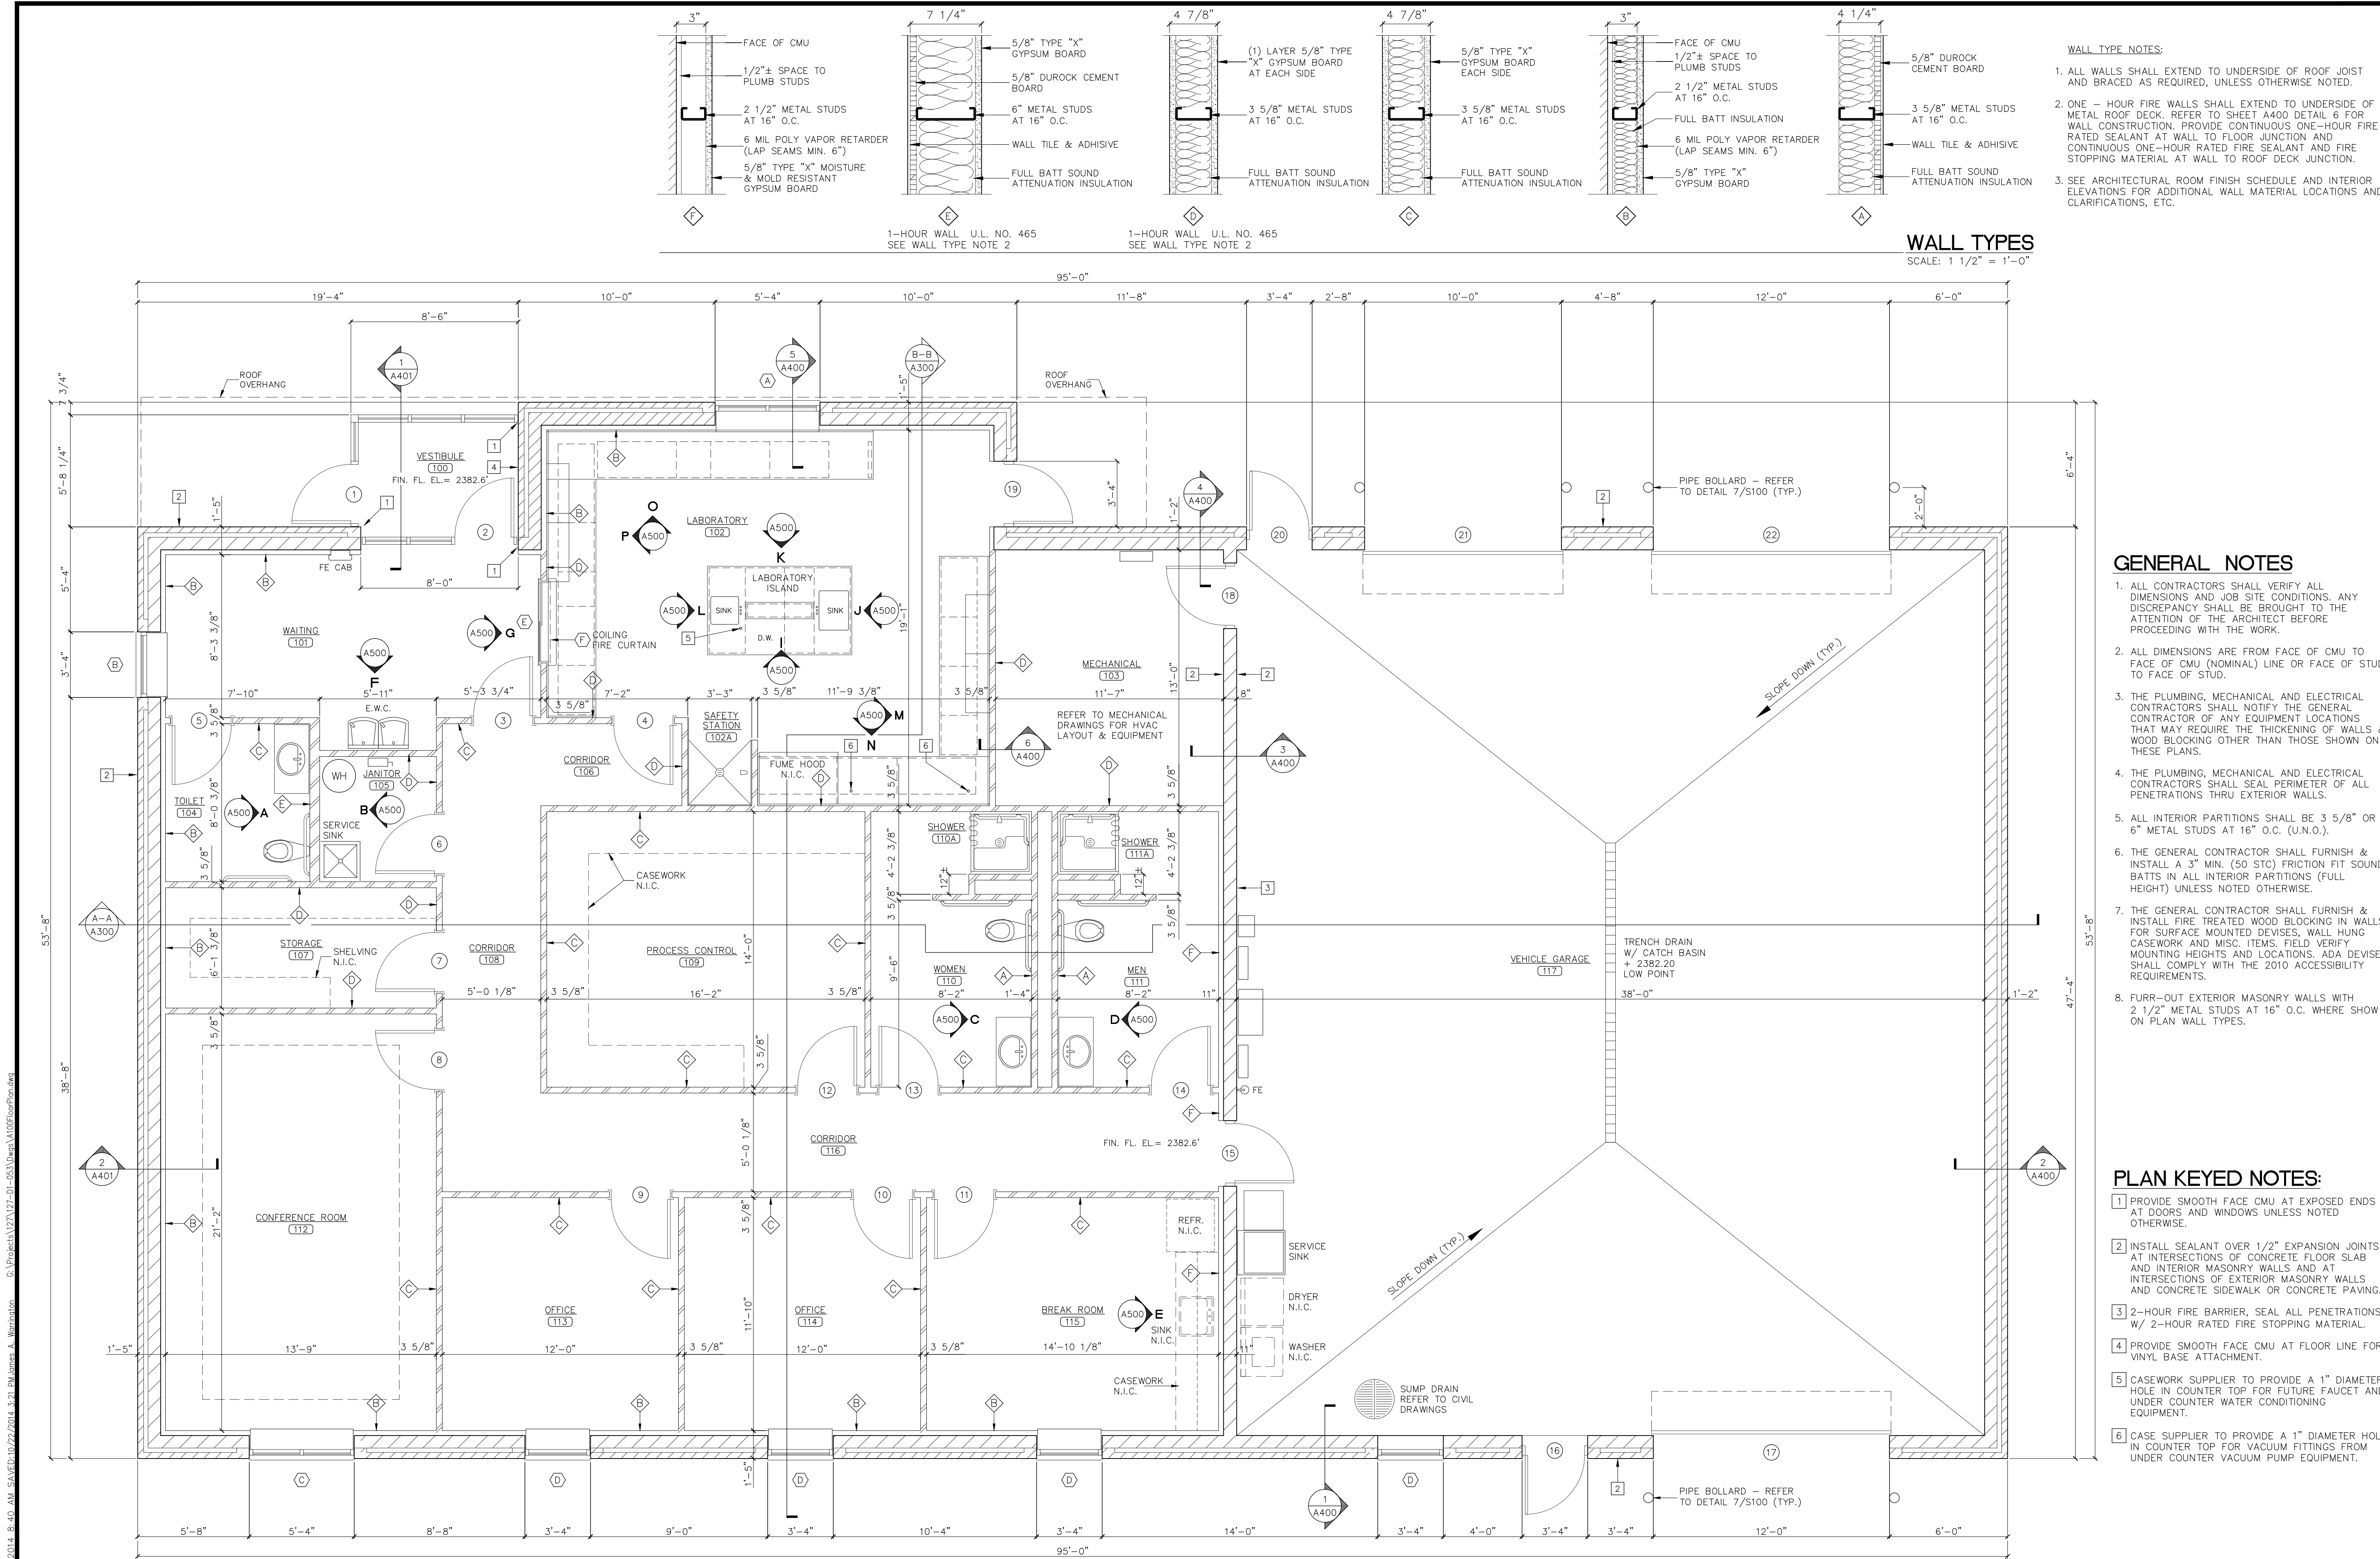
WASTEWATER TREATMENT SUPPORT FACILITY
PROPOSED SITE PLAN
LEXINGTON, NEBRASKA 2014

VERIFY SCALES
BAR IS ONE INCH ON ORIGINAL DRAWING
IF NOT ONE INCH ON THIS SHEET, ADJUST SCALES ACCORDINGLY.

SCALE: AS SHOWN
PROJECT NO. 127-D1-053
DATE: AUGUST, 2014
FIELD BOOK M&A DWG NO. 28454
DRAWN BY: ACO/DM APRVD BY: GAW
SHEET **C100**

PLOTTED: 10/2/2014 12:35 PM. SAVED: 10/7/2014 11:02 AM. D:\DWG\M&A\127-D1-053\Drawn\0100_Site_Plan.dwg

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- WALL TYPE NOTES:**
- ALL WALLS SHALL EXTEND TO UNDERSIDE OF ROOF JOIST AND BRACED AS REQUIRED, UNLESS OTHERWISE NOTED.
 - ONE - HOUR FIRE WALLS SHALL EXTEND TO UNDERSIDE OF METAL ROOF DECK. REFER TO SHEET A400 DETAIL 6 FOR WALL CONSTRUCTION. PROVIDE CONTINUOUS ONE-HOUR FIRE RATED SEALANT AT WALL TO FLOOR JUNCTION AND CONTINUOUS ONE-HOUR RATED FIRE SEALANT AND FIRE STOPPING MATERIAL AT WALL TO ROOF DECK JUNCTION.
 - SEE ARCHITECTURAL ROOM FINISH SCHEDULE AND INTERIOR ELEVATIONS FOR ADDITIONAL WALL MATERIAL LOCATIONS AND CLARIFICATIONS, ETC.

- GENERAL NOTES**
- ALL CONTRACTORS SHALL VERIFY ALL DIMENSIONS AND JOB SITE CONDITIONS. ANY DISCREPANCY SHALL BE BROUGHT TO THE ATTENTION OF THE ARCHITECT BEFORE PROCEEDING WITH THE WORK.
 - ALL DIMENSIONS ARE FROM FACE OF CMU TO FACE OF CMU (NOMINAL) LINE OR FACE OF STUD TO FACE OF STUD.
 - THE PLUMBING, MECHANICAL AND ELECTRICAL CONTRACTORS SHALL NOTIFY THE GENERAL CONTRACTOR OF ANY EQUIPMENT LOCATIONS THAT MAY REQUIRE THE THICKENING OF WALLS & WOOD BLOCKING OTHER THAN THOSE SHOWN ON THESE PLANS.
 - THE PLUMBING, MECHANICAL AND ELECTRICAL CONTRACTORS SHALL SEAL PERIMETER OF ALL PENETRATIONS THRU EXTERIOR WALLS.
 - ALL INTERIOR PARTITIONS SHALL BE 3 5/8" OR 6" METAL STUDS AT 16" O.C. (U.N.O.).
 - THE GENERAL CONTRACTOR SHALL FURNISH & INSTALL A 3" MIN. (50 STC) FRICTION FIT SOUND BATTS IN ALL INTERIOR PARTITIONS (FULL HEIGHT) UNLESS NOTED OTHERWISE.
 - THE GENERAL CONTRACTOR SHALL FURNISH & INSTALL FIRE TREATED WOOD BLOCKING IN WALLS FOR SURFACE MOUNTED DEVICES, WALL HUNG CASEWORK AND MISC. ITEMS. FIELD VERIFY MOUNTING HEIGHTS AND LOCATIONS. ADA DEVICES SHALL COMPLY WITH THE 2010 ACCESSIBILITY REQUIREMENTS.
 - FURR-OUT EXTERIOR MASONRY WALLS WITH 2 1/2" METAL STUDS AT 16" O.C. WHERE SHOWN ON PLAN WALL TYPES.


- PLAN KEYED NOTES:**
- PROVIDE SMOOTH FACE CMU AT EXPOSED ENDS AT DOORS AND WINDOWS UNLESS NOTED OTHERWISE.
 - INSTALL SEALANT OVER 1/2" EXPANSION JOINTS AT INTERSECTIONS OF CONCRETE FLOOR SLAB AND INTERIOR MASONRY WALLS AND AT INTERSECTIONS OF EXTERIOR MASONRY WALLS AND CONCRETE SIDEWALK OR CONCRETE PAVING.
 - 2-HOUR FIRE BARRIER, SEAL ALL PENETRATIONS W/ 2-HOUR RATED FIRE STOPPING MATERIAL.
 - PROVIDE SMOOTH FACE CMU AT FLOOR LINE FOR VINYL BASE ATTACHMENT.
 - CASEWORK SUPPLIER TO PROVIDE A 1" DIAMETER HOLE IN COUNTER TOP FOR FUTURE FAUCET AND UNDER COUNTER WATER CONDITIONING EQUIPMENT.
 - CASE SUPPLIER TO PROVIDE A 1" DIAMETER HOLE IN COUNTER TOP FOR VACUUM FITTINGS FROM UNDER COUNTER VACUUM PUMP EQUIPMENT.

FLOOR PLAN
SCALE: 1/4" = 1'-0"

REVISIONS BY

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**WASTEWATER TREATMENT SUPPORT FACILITY
FLOOR PLAN & WALL TYPES
LEXINGTON, NEBRASKA 2014**

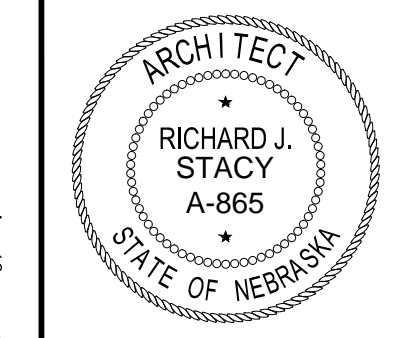

VERIFY SCALES

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SCALE: AS NOTED
PROJECT NO. 127-01-053
DATE: OCTOBER 2014
FIELD BOOK M&A DWG NO. 28444
DRAWN BY: APRVD BY:
SHEET A100 OF

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