GENERAL NOTES:

- 1. GENERAL NOTES APPLY TO ALL TRADES WORKING ON THE PROJECT.
- 2. DO NOT SCALE DRAWINGS.
- VERIFY ALL DIMENSIONS AND REQUIRED CLEARANCES BETWEEN EXISTING CONDITIONS AND SHOP DRAWINGS PRIOR TO FABRICATION AND INSTALLATION.
- 4. CONDUCT OPERATIONS SO AS TO PERMIT PUBLIC ACCESS TO THE EXISTING BUILDINGS. WALKS DRIVEWAY'S AND ENTRANCES TO BE USE BY THE PUBLIC SHALL BE MAINTAINED IN A SAFE CONDITION AND SHALL BE KEPT FREE AND CLEAR OF THE CONTRACTOR'S EQUIPMENT, MATERIALS AND DEBRIS.
- THE DRAWINGS SHOW EXISTING CONDITIONS AS ACCURATE AS POSSIBLE 5. BASED ON AVAILABLE INFORMATION. CONTRACTOR(S) SHALL FIELD VERIFY ALL DIMENSIONS, LOCATIONS, UTILITIES, EQUIPMENT, ETC.. PRIOR TO START OF NEW CONSTRUCTION. REPORT ANY DISCREPANCIES TO THE ARCHITECT BEFORE PROCEEDING W
- CONTRACTOR(S) SHALL COOPERATE WITH THE OWNER IN THE SCHEDULING
 6. AND EXECUTION OF THE WORK AND USE OF THE SITE, CONTRACTOR'S
 SHALL NOTIFY THE OWNER/ARCHITECT A MINIMUM OF 48 HOURS BEFORE
 COMMENCEMENT OF ANY WORK OR OPERATION WHICH WOULD INTERFERE
 WITH THE USE OF THE EXISTING BUILDING.
- 7. CONTRACTOR'S OPERATION AND STORAGE OF MATERIALS SHALL BE CONFIRMED THE THE MINIMUM AREA(S) OF THE SITE NECESSARY TO ACCOMPLISH THE WORK. THE LOCATION OF THE AREA(S) SHALL BE APPROVED BY THE OWNER.

8. CONTRACTOR(S) SHALL EXERCISE ALL REASONABLE PRECAUTIONS FOR THE PROTECTION OF PERSONS AND PROPERTY ON THE SITE. SAFETY PROVISIONS OF APPLICABLE LAWS AND BUILDING AND CONSTRUCTION CODES SHALL BE OBSERVED.

REVISIONS

BUILDING PLAN

LEXINGTON MUNICIPAL

FLOOR

OVERALL

NEBRA


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(earney, NE (308) 234-6456 McCook, NE (308) 345-3710

- 9. CONTRACTOR(S) SHALL PROTECT THEIR WORK, THE WORK OF OTHER AND EXISTING WORK SHOWN TO REMAIN. DO NOT DAMAGE MATERIALS SHOWN TO REMAIN IN PLACE. ANY WORK DAMAGED BY CONTRACTOR(S) SHALL BE RETURNED TO THE CONDITION PRIOR TO DAMAGE AND EQUAL TO ADJACENT SUBJECTS.
- 10. EXISTING EMERGENCY EGRESS SHALL BE MAINTAINED IN ALL SITUATIONS.
- SECURITY SHALL BE MAINTAINED IN ALL SITUATIONS. MAKE PROVISIONS SO THAT THE NORMAL FUNCTIONS OF THE BUILDING CAN BE MAINTAINED THROUGH THE DEMOLITION, REMODELING, AND NEW CONSTRUCTION PERIOD.
- CONTRACTOR SHALL PROVIDE TEMPORARY DUST PROOF ENCLOSURES. DUST
- BARRIERS, COVERED WALKWAYS AND/OR BARRICADES AS REQUIRED TO 12. PROTECT THE PUBLIC, OCCUPANTS AND EXISTING FACILITIES DURING DEMOLITION AND NEW CONSTRUCTION OPERATIONS. CORRIDORS, PASSAGEWAYS AND EMERGENCY EXITS MUST BE KEPT OPEN AND FREE FOR USE AND ACCESS BY OWNER AND THE PUBLIC.
- CONTRACTOR SHALL SEAL ALL PENETRATIONS THROUGH FLOORS, CEILINGS, FIREPROOFING, PERMANENT PARTITIONS, FIRE WALLS AND OTHER FIRE 13. RESISTIVE OR SMOKE CONTROL CONSTRUCTION. CONTRACTOR SHALL SEAL PENETRATIONS SMOKE TIGHT. METAL TRIM OR ESCUTCHEONS ALONE SHALL NOT BE ACCEPTABLE.





BAR IS ONE INCH ON

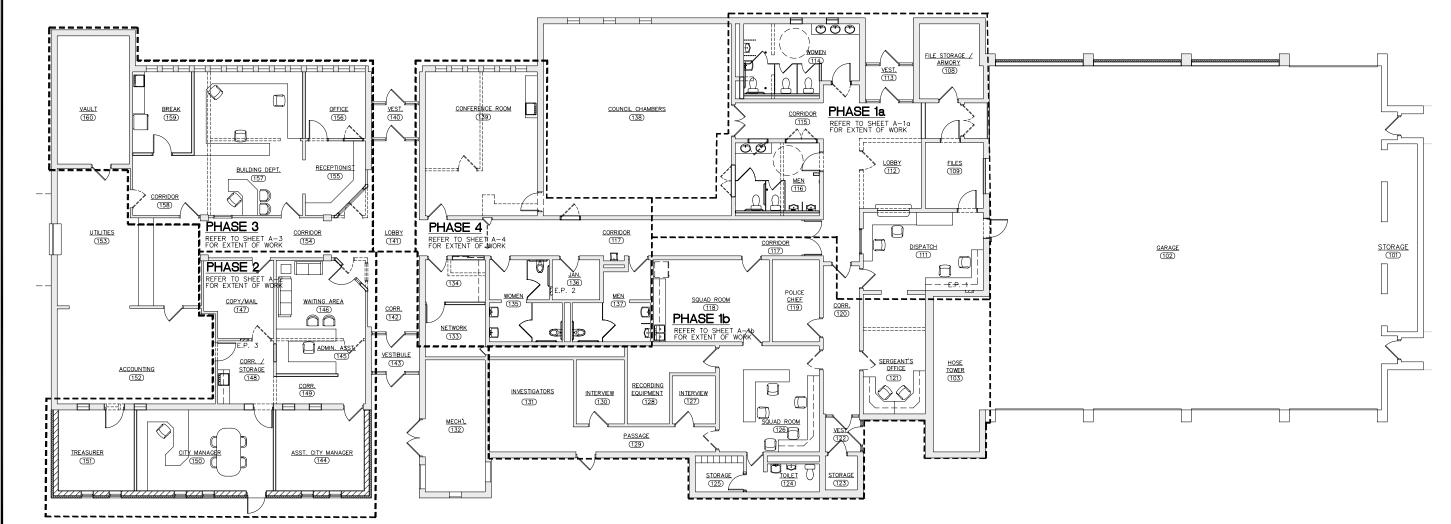ORIGINAL DRAWING

127-G1-098 DATE: OCTOBER 2008
FIELD BOOK M&A DWG NO

DRAWN BY: APRV'D BY:

A-0

OVERALL FLOOR PLAN - PHASING PLAN

	PHASE 1 - ROOM FINISH SCHEDULE FLOOR BASE																										
ROOM NO.		SEALED CONCRETE		4" VINYL	NONE	WAIN	PAINTED	RTH	1 :	SOU	WA JTH	E	S EAS	T	Wi	EST	RY OWNER	EXPOSED STRUCTURE	ING		CEILING HEIGHT		f	REMA	ARKS	5	
102 104 105 106 107 108 109 110 111 112 113 114 115 116 117 118 119 124 125 126 129 131	GARAGE TRAINING AREA SHOWER ROOM SHOWER ROOM COKKERS FILE STORAGE & ARMORY FILES FILE STORAGE & ARMORY FILES WOMEN CORRIDOR CORRIDOR CORRIDOR MEN CORRIDOR MEN CORRIDOR MEN CORRIDOR MEN SQUAD ROOM POLICE CHIEF TOILET STORAGE SQUAD ROOM PASSAGE INVESTIGATORS																			8	3'-0"	X					
200	EVIDENCE							\parallel	\pm		+				\pm			Ė		E							

GENERAL DEMOLITION NOTES

CONTRACTOR IS RESPONSIBLE FOR ON—SITE VISITS TO DETERMINE THE ACTUAL CONDITIONS AND EXTENT OF WORK REQUIRED FOR DEMOLITION.

ANY DAMAGE TO THE PROPERTY, WHICH IS TO REMAIN IN USE, SHALL BE REPAIRED WITHOUT ADDITIONAL EXPENSE TO THE OWNER.

ITEMS SCHEDULED FOR DEMOLITION INCLUDE, BUT NOT LIMITED TO:
DOORS, WIRING, ELECTRICAL FIXTURES, GALVANIZED AND COPPER PIPING AND MECHANICAL EQUIPMENT. TRASH AND DEBRIS SHALL BE REMOVED FROM THE SITE IMMEDIATELY.

DEMOLITION NOTES (KEYED TO PLAN)

- TEMOVE CEILING, METAL STUD AND GPDW WALL SYSTEM AS SHOWN. PATCH AND REPAIR ADJACENT WALLS AND FLOOR. PREPARE SURFACES FOR NEW FINISH. REFER TO FINISH SCHEDULE.
- (2) REMOVE DOOR, FRAME AND HARDWARE COMPLETELY. IN-FILL OPENING WITH NEW 8" CMU.
- (3) REMOVE OVERHEAD DOOR, FRAME AND CONCRETE AT OPENINGS SEE FLOOR PLAN A-1. REMOVE EXISTING GRANULAR FILL UNDER OVERHEAD DOOR TO HAVE INFILL SEE DETAIL 1 SHEET A-7.
- 4 REMOVE EXISTING CMU WALL.
- (5) REMOVE PARTIAL CMU WALL FOR OPENINGS.
- 6 REMOVE EXISTING WALL.

WALL TYPES

- A IN-FILL EXISTING OPENING WITH 8" CMU AND FACE BRICK TO MATCH EXISTING AFTER EXISTING WINDOW & FRAME IS REMOVED REFER TO DETAIL X, A-7.
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- C IN-FILL EXISTING OPENING WITH 8" CMU


 AFTER EXISTING DOOR & FRAME IS
 REMOVED REFER TO DETAIL X, A-7.
- D 3 5/8" METAL STUDS AT 16" O.C., 5/8" TYPE "X" GYPSUM WALL BOARD (G.W.B.) EACH SIDE. EXTEND TO BOTTOM OF EXISTING ROOF,
- E 3 5/8" METAL STUDS AT 16" O.C. WITH 3 1/2" SOUND ATTENUATION BLANKET, 5/8" TYPE "X" GYPSUM BOARD (G.W.E., ONE SIDE, EXTEND WALL TO BOTTOM OF ROOF.

LEGEND

EXISTING WALLS TO REMAIN \equiv \equiv \equiv \equiv EXISTING WALLS TO BE REMOVED

NEW GWB PARTITION

NEW DOOR & FRAME ---DOOR DESIGNATION

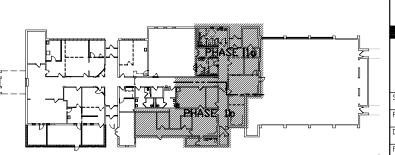

PHASE 1a - FLOOR PLAN
SCALE: 1/8" = 1'-0"

3 A=1

114

(116)

<u>POLICE</u>

CORRIDOR (117)

(SIM. TO DET.

<u>VEST.</u> (113)

4

(c)

EVIDENCE STORAGE
(108)

(108)

(

2,

(109)

(5)

E.P. 1

(111)

KEY PLAN

REVISIONS

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Kearney, NE (308) 234-6456 McCook, NE (308) 345-3710

BUILDING

LEXINGTON MUNICIPAL

PLAN NEBRASKA

FLOOR ON, I Ø \mathbf{T}

LEXINGT **PHASE**

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0 1"
IF NOT ONE INCH ON THIS SHEET, ADJUST SCALES ACCORDINGLY.


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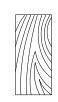
A-1a


127-G1-098 AUGUST 2007
FIELD BOOK M&A DWG NO


DRAWN BY: APRV'D BY:

	PHASE 1 - DOOR SCHEDULE														
MARK	TYPE	WIDTH	HEIGHT	THICHN'S	FRAME	LABEL	HDWR.	REMARKS							
104	1	3'-0'	7'-0"	1 3/4"	AL #I		1	DETAIL 1, 2, 3							
105		30.	7'-0"	1 3/4"											
106		3'-0'	7'-0"	1 3/4"											
108		3'-0'	7'-0"	1 3/4"											
109		30.	7:-0"	1 3/4"											
110		3'-0'	7'-0"	I 3/4"											
111		3'-0'	7'-0"	1 3/4"											
114		3:-0:	7'-0"	1 3/4"											
116		3'-0'	7'-0"	1 3/4"											
117		PR. 3'-O'	7'-O'												
125		3:-0:	7'-0"												



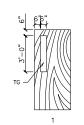

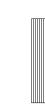

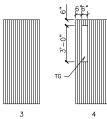

1 3/4" SOLID CORE 1 3/4" SOLID CORE WOOD DOOR HOLLOW METAL - 1 3/4" HOLLOW METAL - GALV. - PAINTED GALV. - INSUL. - PAINTED

DOOR TYPES SCALE: 1/4" = 1'-0"



CONTRACTOR IS RESPONSIBLE FOR ON—SITE VISITS TO DETERMINE THE ACTUAL CONDITIONS AND EXTENT OF WORK REQUIRED FOR DEMOLITION.

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- igappa REMOVE EXISTING CMU WALL.
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- C IN-FILL EXISTING OPENING WITH 8" CMU


 AFTER EXISTING DOOR & FRAME IS
 REMOVED REFER TO DETAIL X, A-7.
- D 3 5/8" METAL STUDS AT 16" O.C.,
 5/8" TYPE "X" GYPSUM WALL BOARD
 (G.W.B.) EACH SIDE. EXTEND TO
 BOTTOM OF EXISTING ROOF,
- E 3 5/8" METAL STUDS AT 16" O.C. WITH 3 1/2" SOUND ATTENUATION BLANKET, 5/8" TYPE "X" GYPSUM BOARD (G.W.E., ONE SIDE, EXTEND WALL TO BOTTOM OF ROOF.


LEGEND

EXISTING WALLS TO REMAIN ===== EXISTING WALLS TO BE REMOVED

NEW GWB PARTITION EXISTING DOOR TO REMAIN

NEW DOOR & FRAME ---DOOR DESIGNATION

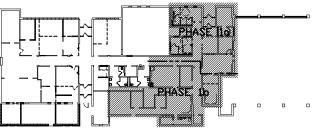

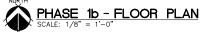

SQUAD ROOM (126)

10|LET (124)


(117)

CORR. (120)

VEST. (122)

STORAGE (123)

SERGEANTS (121)

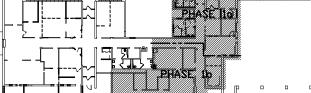

KEY PLAN NO SCALE

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McCook, NE (308) 345-3710

PLAN NEBRASKA FLOOR

BUILDING

LEXINGTON MUNICIPAL

ON, I 0 LEXINGT \mathbf{T} **PHASE**

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IF NOT ONE INCH ON THIS SHEET, ADJUST SCALES ACCORDINGLY.

AS NOTED 127-G1-098

AUGUST 2007
FIELD BOOK M&A DWG N DRAWN BY: APRV'D BY:

INTERVIEW


(130)

(125)

SQUAD ROOM (118)

INTERVIEW (127)


PASSAGE (129)

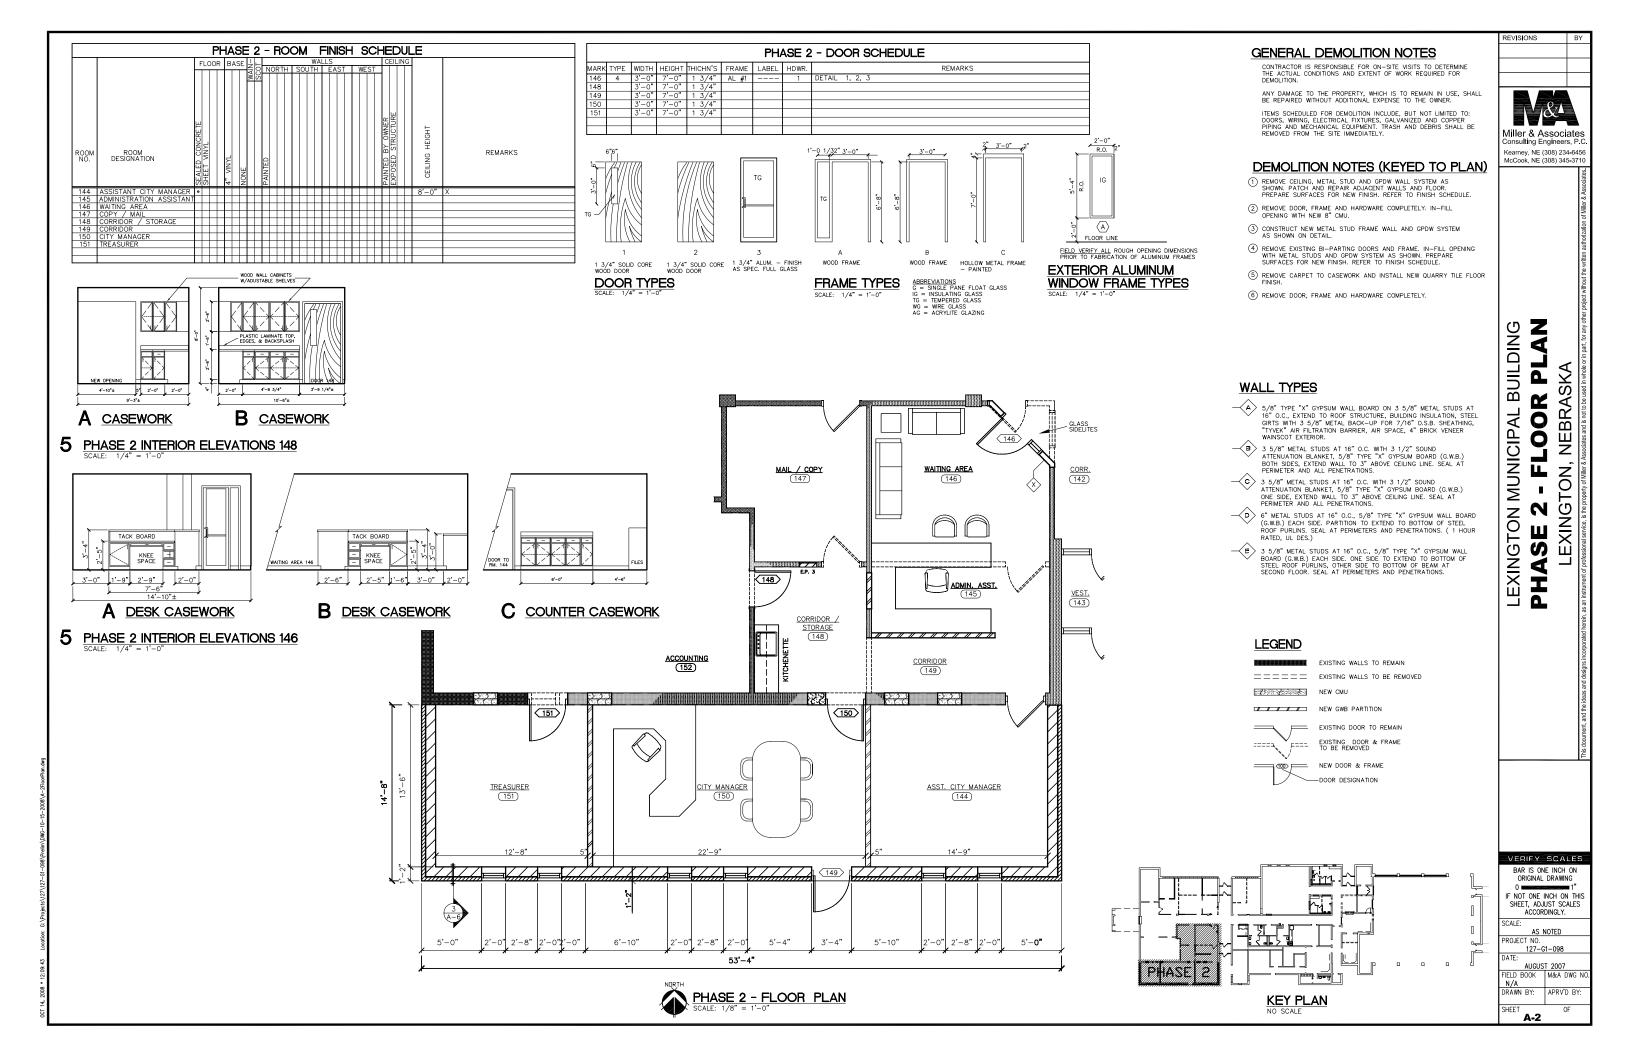

			Р	HA	SE	3 -	RC	ON	1	FIN	IISI	Н	SC	HE	:Dl	JLE	
ROOM NO.		SEALED CONCRETE SHEET VINYL	NIN/L			HAINTED	H S	W/DUTH	ALLS	AST	V	WEST	INTED	ILIN	√G	CEILING HEIGHT	REMARKS
136 150 151 152 153 154 155	LOBBY RECEPTIONIST SPARE OFFICE BUILDING DEPARTMENT CORRIDOR BREAK ROOM VAULT	● SE	4	NONE		PA							PA			8'-0"	X

MARK	TYPE	WIDTH	HEIGHT	THICHN'S	FRAME	LABEL	HDWR.	REMARKS
151	1	30.	7'-0"	1 3/4"	AL #I		1	DETAIL 1, 2, 3
154	1	3:-0:	7-0	1 3/4"	AL. #2		2	
	3,-0"	" 1				3'-6" 3'-8" R.O.	FLOOR	6'-0" R.O.
	1 3/4" CORE V	SOLID VOOD DO	OR W	3/4" SOLI	D CORE	DIME	D VERIFY INSIONS I IINUM FR	'ALL ROUGH OPENING PRIOR TO FABRICATION OF AMES
	DO SCALE:	OR 1	YPES	3				R ALUMINUM

PHASE 3 - DOOR SCHEDULE

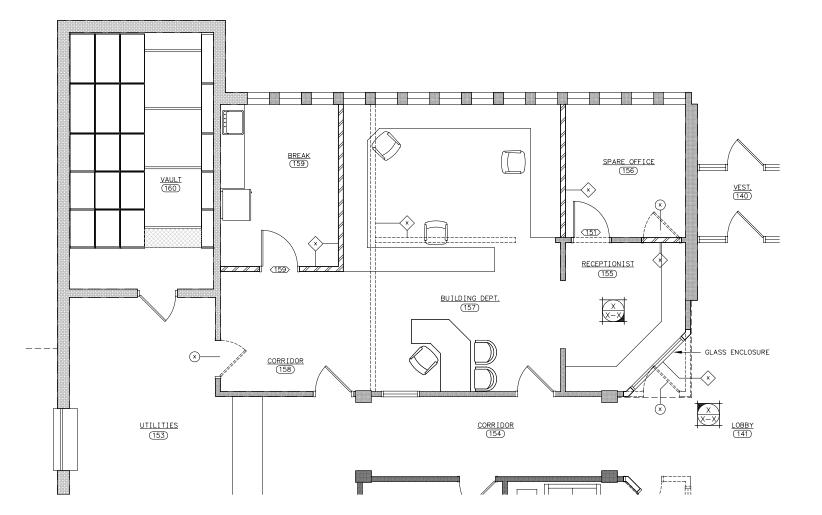

GENERAL DEMOLITION NOTES

ANY DAMAGE TO THE PROPERTY, WHICH IS TO REMAIN IN USE, SHALL BE REPAIRED WITHOUT ADDITIONAL EXPENSE TO THE OWNER.

REVISIONS

Miller & Associates Consulting Engineers, P.C earney, NE (308) 234-6456

McCook, NE (308) 345-371

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PHASE

NEBRASKA

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BUILDING

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LEXINGTON

ITEMS SCHEDULED FOR DEMOLITION INCLUDE, BUT NOT LIMITED TO: DOORS, WIRING, ELECTRICAL FIXTURES, GALVANIZED AND COPPER PIPING AND MECHANICAL EQUIPMENT. TRASH AND DEBRIS SHALL BE REMOVED FROM THE SITE IMMEDIATELY.

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- 3 CONSTRUCT NEW METAL STUD FRAME WALL AND GPDW SYSTEM AS SHOWN ON DETAIL.
- 4 REMOVE EXISTING BI-PARTING DOORS AND FRAME. IN-FILL OPENING WITH METAL STUDS AND GPDW SYSTEM AS SHOWN. PREPARE SURFACES FOR NEW FINISH. REFER TO FINISH SCHEDULE.
- (5) REMOVE CARPET TO CASEWORK AND INSTALL NEW QUARRY TILE FLOOR FINISH.
- 6 REMOVE DOOR, FRAME AND HARDWARE COMPLETELY.

WALL TYPES

- 5/8" TYPE "X" GYPSUM WALL BOARD ON 3 5/8" METAL STUDS AT 16" O.C., EXTEND TO ROOF STRUCTURE, BUILDING INSULATION, STEEL GIRTS WITH 3 5/8" METAL BACK-UP FOR 7/16" O.S.B. SHEATHING. "TYPSKE" AIR FILTRATION BARRIER, AIR SPACE, 4" BRICK VENEER WAINSCOT EXTERIOR.
- B
 3 5/8" METAL STUDS AT 16" O.C. WITH 3 1/2" SOUND
 ATTENUATION BLANKET, 5/8" TYPE "X" GYPSUM BOARD (G.W.B.)
 BOTH SIDES, EXTEND WALL TO 3" ABOVE CEILING LINE. SEAL AT
 PERIMETER AND ALL PENETRATIONS.
- 3 5/8" METAL STUDS AT 16" O.C. WITH 3 1/2" SOUND ATTENUATION BLANKET, 5/8" TYPE "X" GYPSUM BOARD (G.W.B.) ONE SIDE, EXTEND WALL TO 3" ABOVE CEILING LINE. SEAL AT PERIMETER AND ALL PENETRATIONS.
- D 6" METAL STUDS AT 16" O.C., 5/8" TYPE "X" GYPSUM WALL BOARD (G.W.B.) EACH SIDE. PARTITION TO EXTEND TO BOTTOM OF STEEL ROOF PURLINS. SEAL AT PERIMETERS AND PENETRATIONS. (1 HOUR RATED, UL DES.)
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LEGEND

EXISTING WALLS TO REMAIN ===== EXISTING WALLS TO BE REMOVED

NEW CMU NEW GWB PARTITION

EXISTING DOOR TO REMAIN

NEW DOOR & FRAME - DOOR DESIGNATION





KEY PLAN NO SCALE

BAR IS ONE INCH ON ORIGINAL DRAWING IF NOT ONE INCH ON THIS

SHEET, ADJUST SCALES
ACCORDINGLY. AS NOTED


127-G1-098 AUGUST 2007
FIELD BOOK M&A DWG N

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ROOM NO.	ROOM DESIGNATION	SEALED CONCRETE SHEET VINYL	4" VINYL	NONE WAIN-	PAINTED	RTH		ALLS	AST	WES	ST	EXPOSED STRUCTURE		PEMARKS
127 128 129 130 131	MEN JANITOR WOMEN NETWORK	•											8'-0	-0" X
132 134	CORRIDOR CONFERENCE ROOM													

			PHASE 4 - DOOR SCHEDULE														
MARK	TYPE	WIDTH	HEIGHT	THICHN'S	FRAME	LABEL	HDWR.	REMARKS									
130	1	3'-0"	7'-0"	1 3/4"	AL #I		1	DETAIL 1, 2, 3									
134		30.	7-0	1 3/4"													



PHASE 4 - FLOOR PLAN

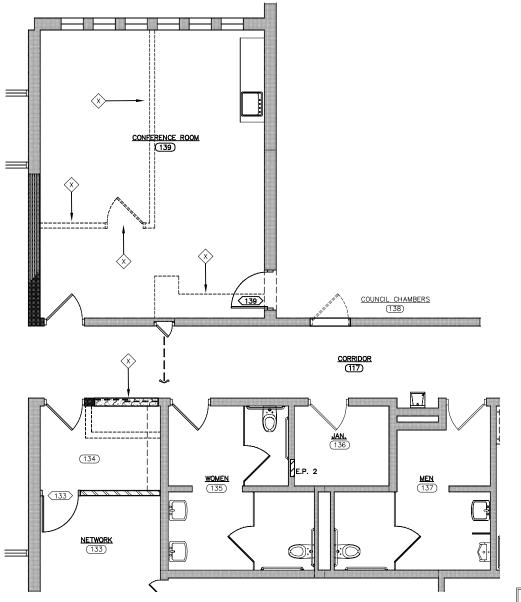GENERAL DEMOLITION NOTES

ANY DAMAGE TO THE PROPERTY, WHICH IS TO REMAIN IN USE, SHALL BE REPAIRED WITHOUT ADDITIONAL EXPENSE TO THE OWNER.

ITEMS SCHEDULED FOR DEMOLITION INCLUDE, BUT NOT LIMITED TO: DOORS, WIRING, ELECTRICAL FIXTURES, GALVANIZED AND COPPER PIPING AND MECHANICAL EQUIPMENT. TRASH AND DEBRIS SHALL BE REMOVED FROM THE SITE IMMEDIATELY.

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- 3 CONSTRUCT NEW METAL STUD FRAME WALL AND GPDW SYSTEM AS SHOWN ON DETAIL.
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WALL TYPES

- 5/8" TYPE "X" GYPSUM WALL BOARD ON 3 5/8" METAL STUDS AT 16" O.C., EXTEND TO ROOF STRUCTURE, BUILDING INSULATION, STEEL GIRTS WITH 3 5/8" METAL BACK—UP FOR 7/16" O.S.B. SHEATHING, "TYVEK" AIR FILTRATION BARRIER, AIR SPACE, 4" BRICK VENEER WAINSCOT EXTERIOR.

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LEGEND

EXISTING WALLS TO REMAIN

===== EXISTING WALLS TO BE REMOVED

NEW GWB PARTITION

NEW DOOR & FRAME ---DOOR DESIGNATION



KEY PLAN NO SCALE

REVISIONS

Miller & Associates

Consulting Engineers, P.0 Kearney, NE (308) 234-6456 McCook, NE (308) 345-371

PLAN

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MUNICIPAL

LEXINGTON

NEBRASKA FLOOR ON, ı EXING1 4 **PHASE**

BAR IS ONE INCH ON ORIGINAL DRAWING

IF NOT ONE INCH ON THIS SHEET, ADJUST SCALES
ACCORDINGLY.

AS NOTED

127-G1-098 AUGUST 2007
FIELD BOOK M&A DWG NO

DRAWN BY: APRV'D BY: